


DANSHES CENTER ON THE PIKE

SAINT MARYS P214 PROJECT PLAN PJT2023-00016

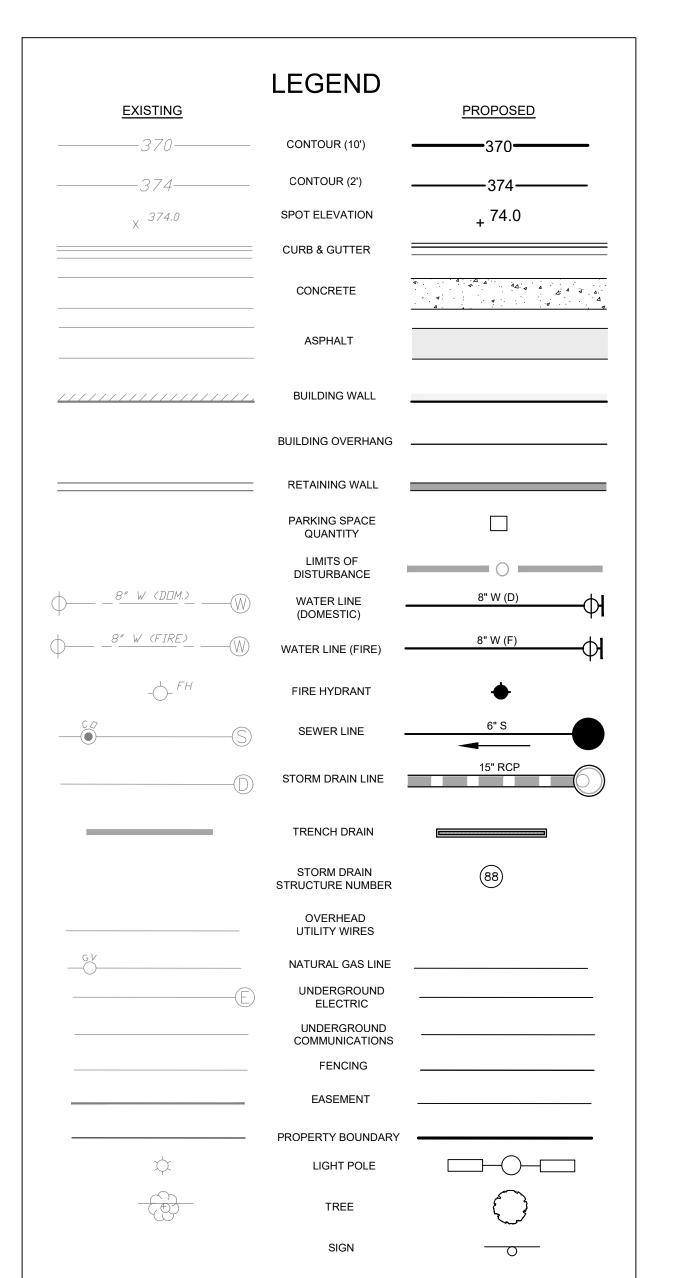

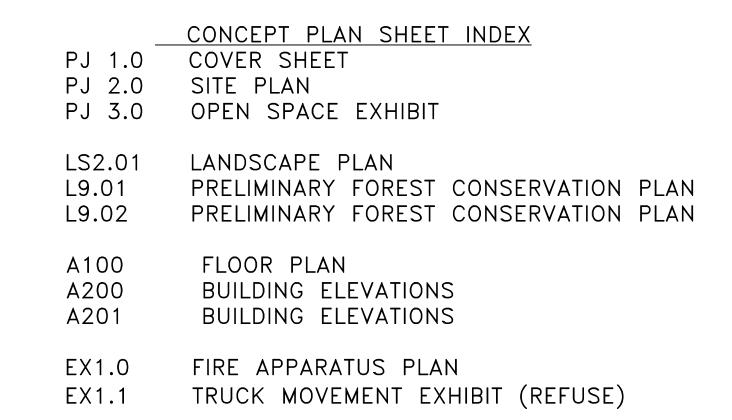

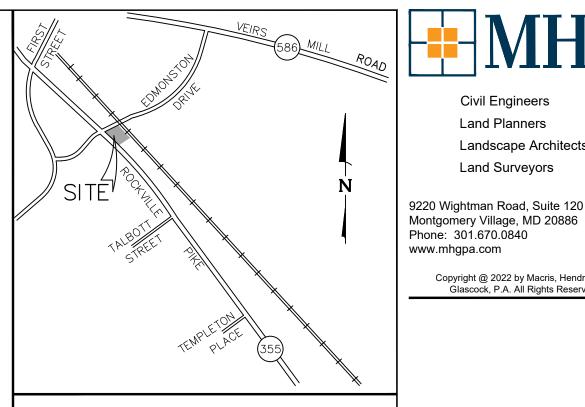

VICINITY MAP SCALE 1" = 2,000"

SITE DATA SUBJECT PROPERTY: PARCEL 214, L-28469 F-567 TRACT AREA: 25,862 S.F. OR 0.59 AC. **ROW DEDICATION** 6,523 S.F. OR 0.15 AC LOT AREA: 19,339 S.F. OR 0.44 AC

TAX ACCOUNT No.:

PROPOSED USE:

PD-CB (CHAMPION BILLIARDS) WITH A DESIGNATED EQUIVALENT ZONING CLASSIFICATION: ZONE OF MXCD (MIXED USE CORRIDOR DISTRICT)

ROCKVILLE NEIGHBORHOOD PLAN MIDDLE/NORTH PIKE-EAST PLANNING AREA (SECT. 25.14.34.b)

PROPERTY ADDRESS: 900 ROCKVILLE PIKE

04-02406134

	REQUIRED/ALLOWED	PROPOSED
TRACT AREA	NONE PRESCRIBED	25,862 S.F. or 0.59 AC
BUILDING SETBACK REQUIREMENTS		
ROCKVILLE PIKE EDMONSTON DRIVE SIDE – MXCD ZONE REAR - WMATA BUILD-TO-LINE REQUIREMENT (SECT. 25. 13.05. b)	0' 0' 0' OR 10' 0' OR 10' 85' MAX. (1)	0' 0' 150' 15' 92'
MAXIMUM BUILDING HEIGHT (SECT.25.13.05.b.2.b.ii) BUILDING AREA	75' NONE PRESCRIBED	26.67'(2) 4,400 S.F. (2)
PARKING SETBACK REQUIREMENTS ROCKVILLE PIKE (SECT. 4.d.2(a) SIDE - MXCD ZONE (SECT. 4.d.2(b)(iv	10') 7'	10' 10'
REAR - WMATA (SECT. 4.d.2(b)(iv)	7 15.0% or 2.900 S.E.	4' (3)
SITE OPEN SPACE (4)(5) -Min. PUBLIC USE SPACE (4)(5)-Min. *APPLICANT TO PROVIDE A MINIMUM OF 159	15.0% or 2,900 S.F. 15.0% or 2,900 S.F. % OPEN SPACE	33% or 6,500 S.F.*
OFF STREET PARKING AND LOADING PARKING		
RETAIL (4,400 S.F.) (1)	1/200 S.F. = 22 SPACE	23 SPACES
HANDICAP ACCESSIBLE SPACES	1	1 (VAN SPACE)
LOADING SPACE	1	1
BICYCLE SPACES - LONG TERM (LT), RETAIL (4,400 S.F.) (2)	SHORT TERM (ST) ST 2/5K S.F. = 2 LT 2/12K S.F. = 1	4 ST BIKE SPAC 1 LT LOCKER
SURFACE PARKING FACILITY	<u> </u>	, El ESCREIX

NOTES:

INTERNAL LANDSCAPING

PARKING LOT AREA = 8,285 S.F.

1. THE BUILD TO LINE REPRESENTS THE MAXIMUM SETBACK FOR THE SITE. AS PART OF PDP-2006-00011, THE MAYOR AND COUNCIL GRANTED AN EXCEPTION TO REDUCE THE BUILD-TO LINE TO 85' FROM THE CENTERLINE OF THE OF THE STREET TO THE BUILDING FOR LOTS THAT ARE NARROWER THAN 300 FEET ALONG ROCKVILLE PIKE. AS PART OF: THE SITE DEVELOPMENT PLAN, A REDUCTION OF THE 85' MAXIMUM SETBACK.

5.0% or 414 S.F.

8% or 677 S.F.

- 2. INFORMATION PROVIDED BY PROJECT ARCHITECT 3. PURSUANT TO SECTION 4.d.3.(b)(iv) OF THE LANDSCAPE, SCREENING, AND LIGHTING MANUAL THE PERIMETER LANDSCAPE REQUIREMENT MAY BE REDUCED BY THE PLANNING COMMISSION TO ACHIEVE A BETTER DESIGN SOLUTION PER THE PROVISION OF WALLS OR FENCES. SEE LANDSCAPE PLAN (SHEET LS 2.01)
- 4. PURSUANT TO SECTION 25.13.05.b, SITE WITH LESS THAN 20,000 S.F. AND WITHIN THE ROCKVILLE NEIGHBORHOOD PLAN AREA REQUIRE 15% PUBLIC OPEN SPACE AND 15% OPEN SPACE. 5. PURSUANT TO SECTION 25.03.02, PUBLIC OPEN SPACE MAY CONSIST OF OPEN AREAS RECOMMENDED IN THE MASTER PLAN, INCLUDING ENHANCED PUBLIC WALKWAYS AND OFF-SITE PUBLIC IMPROVEMENTS. THE PROPOSED SHARED USE PATH HAS BEEN INCLUDED IN THE PUBLIC OPEN SPACE CALCULATION. SEE OPEN SPACE EXHIBIT, SHEET PJ3.0

THE BUILDING FOOTPRINTS, BUILDING HEIGHTS, ON-SITE PARKING, SITE

CIRCULATION, AND SIDEWALKS SHOWN ON THIS PRELIMINARY PLAN OF

SUBDIVISION ARE ILLUSTRATIVE. THE FINAL LOCATIONS OF BUILDINGS,

CONDITIONS OF THE PLANNING BOARD'S APPROVAL.

STRUCTURES AND HARDSCAPE WILL BE DETERMINED AT THE TIME OF SITE PLAN.

PLEASE REFER TO THE ZONING DATA TABLE FOR DEVELOPMENT STANDARDS

SUCH AS SETBACKS, BUILDING HEIGHT, AND LOT COVERAGE FOR EACH LOT.

OTHER LIMITATIONS FOR SITE DEVELOPMENT MAY ALSO BE INCLUDED IN THE

Professional Certification hereby certify that these documents were prepared of approved by me, and that I am a duly licensed Maryland. Lic. No. 16905 Exp. Date. 04.21.2024

Civil Engineers Land Planners

Land Surveyors

Landscape Architects

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OWNER: J DANSHES, LLC 9213 WINTERSET DR

jdanshes@yahoo.com

POTOMAC, MD 20854

GTM ARCHITECTS 7735 OLD GEORGETOWN ROAD SUITE 700 BETHESDA, MD, 20814 JEFF WHITMAN, RA 240-333-2067

MILLER, MILLER & CANBY 200-B MONROE STREET ROCKVILLE, MD, JODY KLINE 301-738-2051

REV	ISIONS	
NO.	DESCRIPTION	DATE
	SUBMIT PROJECT PLAN	12/13/22
	ADDRESS DRC COMMENTS	5/8/23
	ADDRESS CITY	08/11/
	COMMENTS	2023
		•

WSSC 217NW06

L. 44329 F. 159 4TH ELECTION DISTRICT

CITY OF ROCKVILLE MARYLAND

THE PIKE

DANSHES CENTER ON

ST. MARY'S PARCEL P214


PROJ. MGR	BJD
DRAWN BY	BJD/KDJ
SCALE	1"= 20'
DATE	11/09/22

PROJECT PLAN **COVER SHEET**

SHEET NO.

PROJECT NO. 2004.115.33 OF

FOR UTILITY LOCATIONS **CONTACT "ONE CALL" AT 811** AT LEAST 48 HOURS PRIOR TO CONSTRUCTION

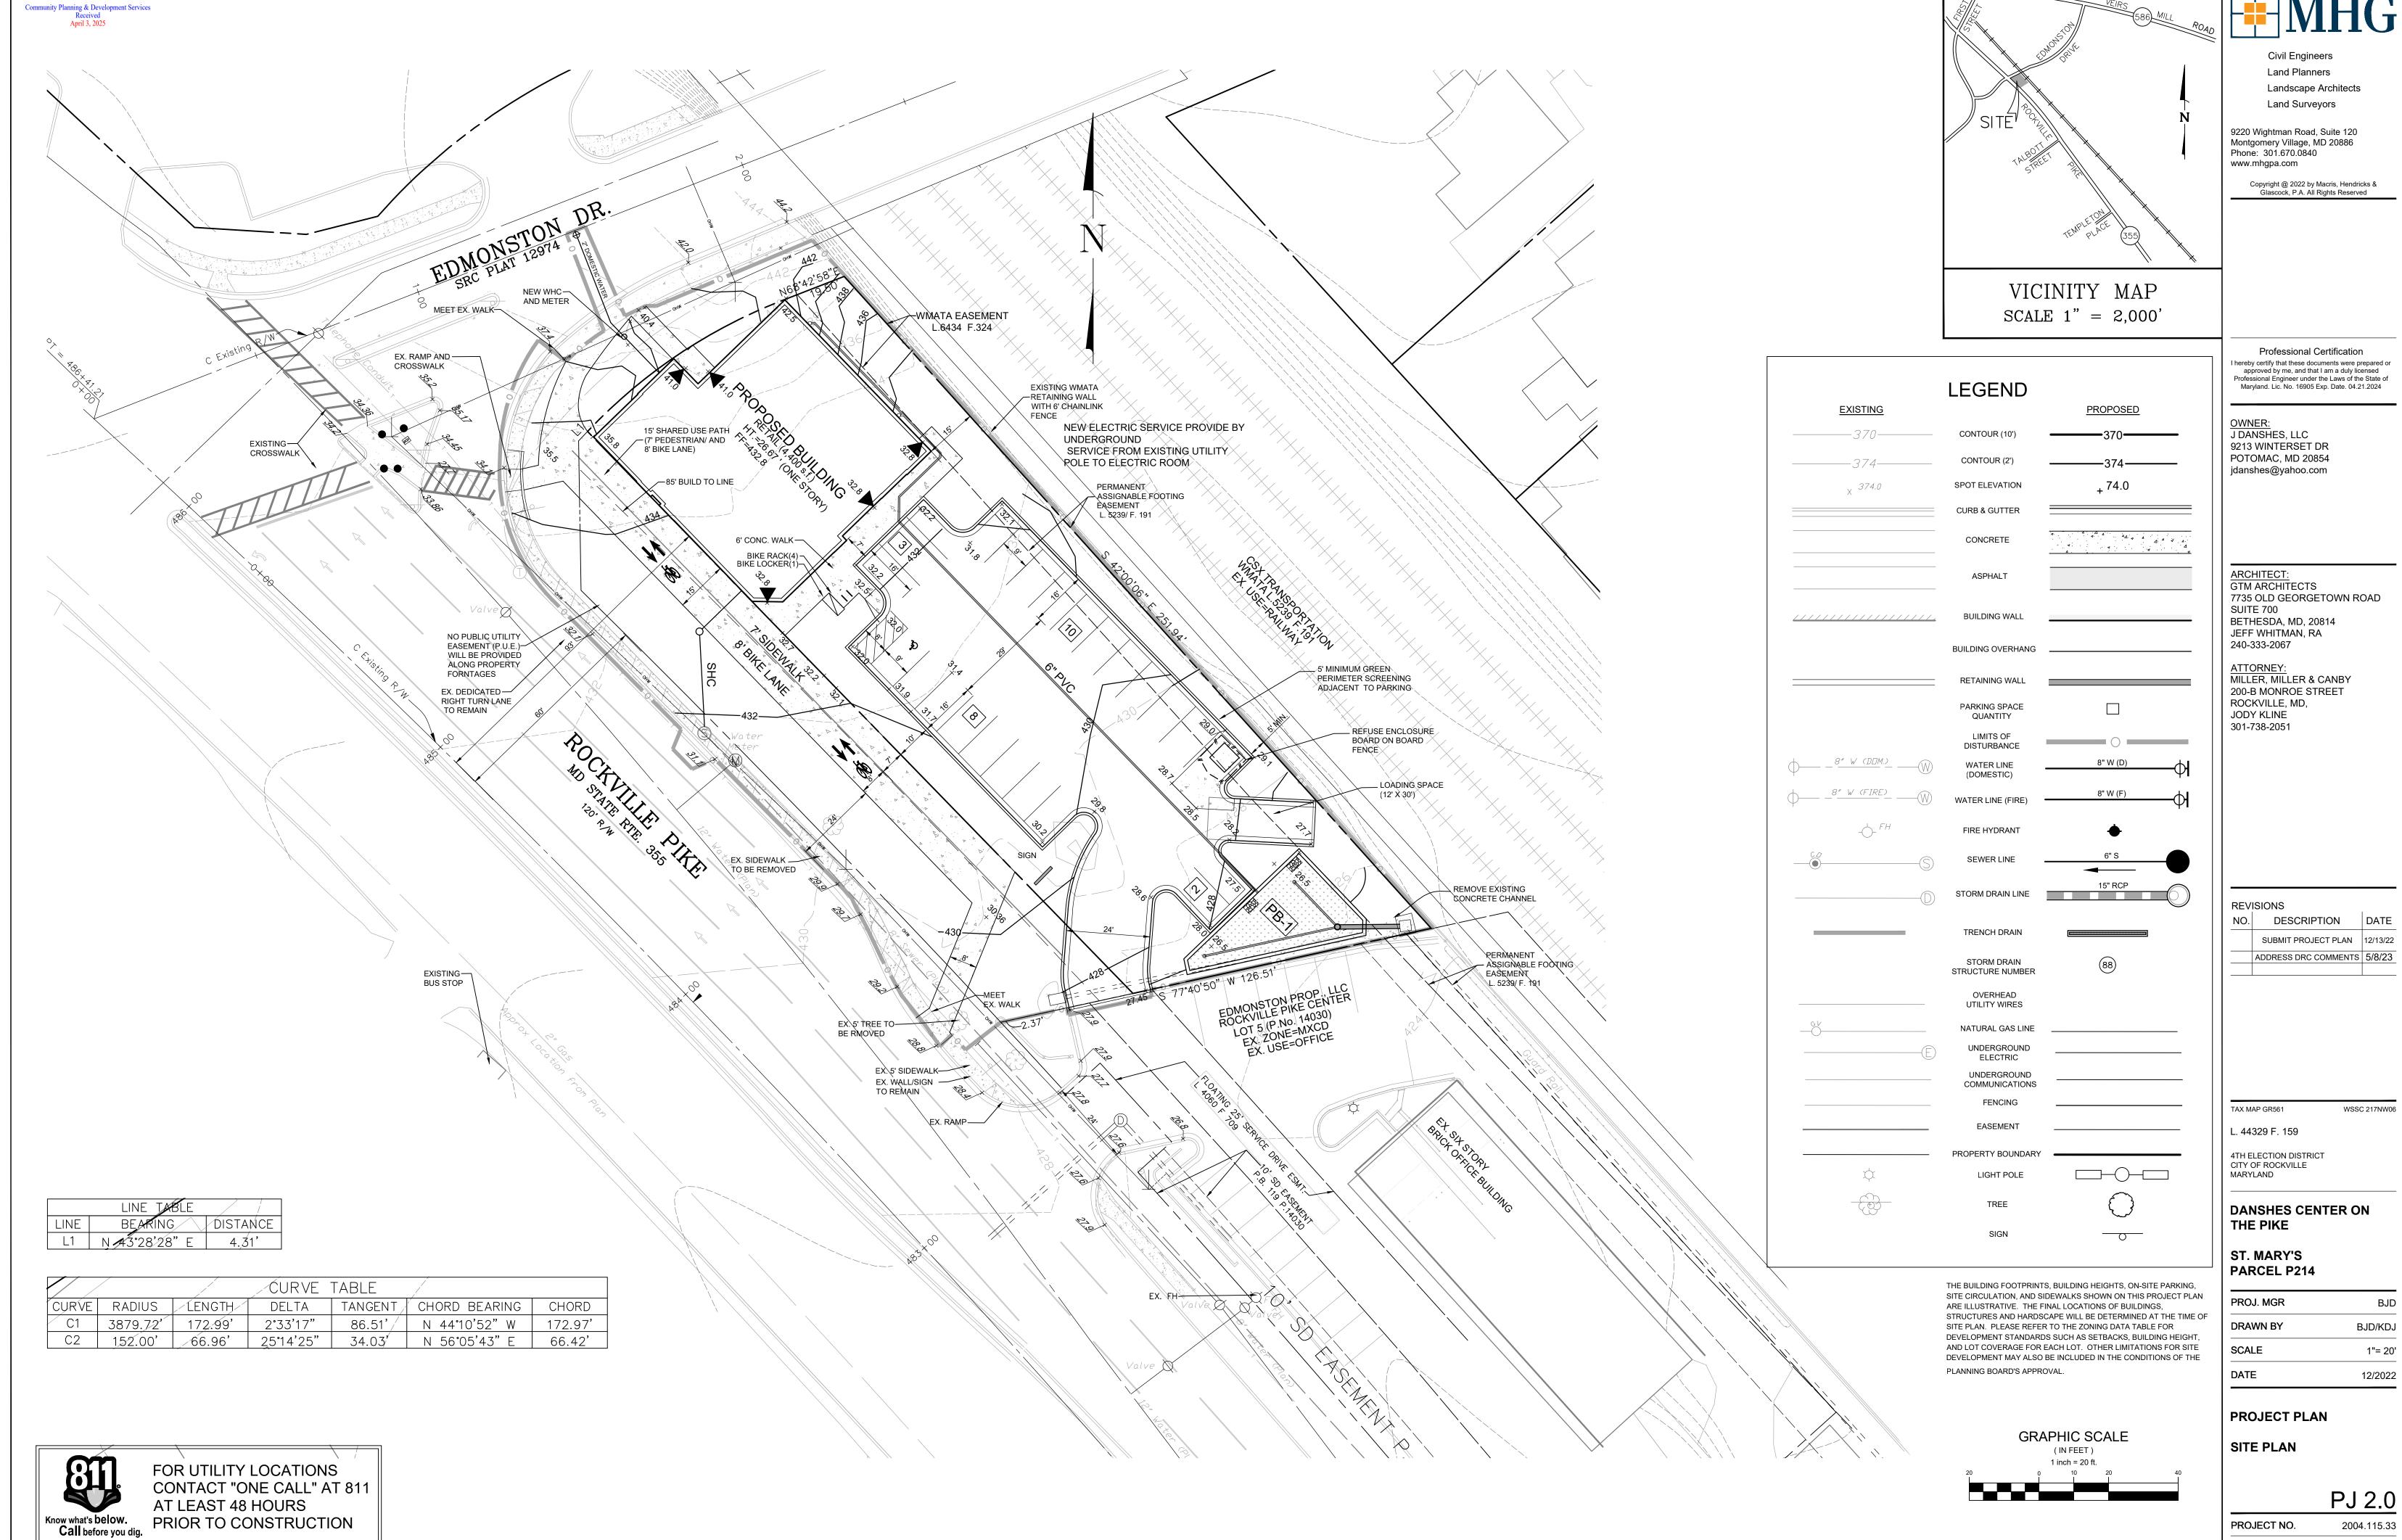


ADDRESS DRC COMMENTS 5/8/23

BJD BJD/KDJ 1"= 20' 12/2022

PROJECT NO. 2004.115.33

SHEET NO.

OF

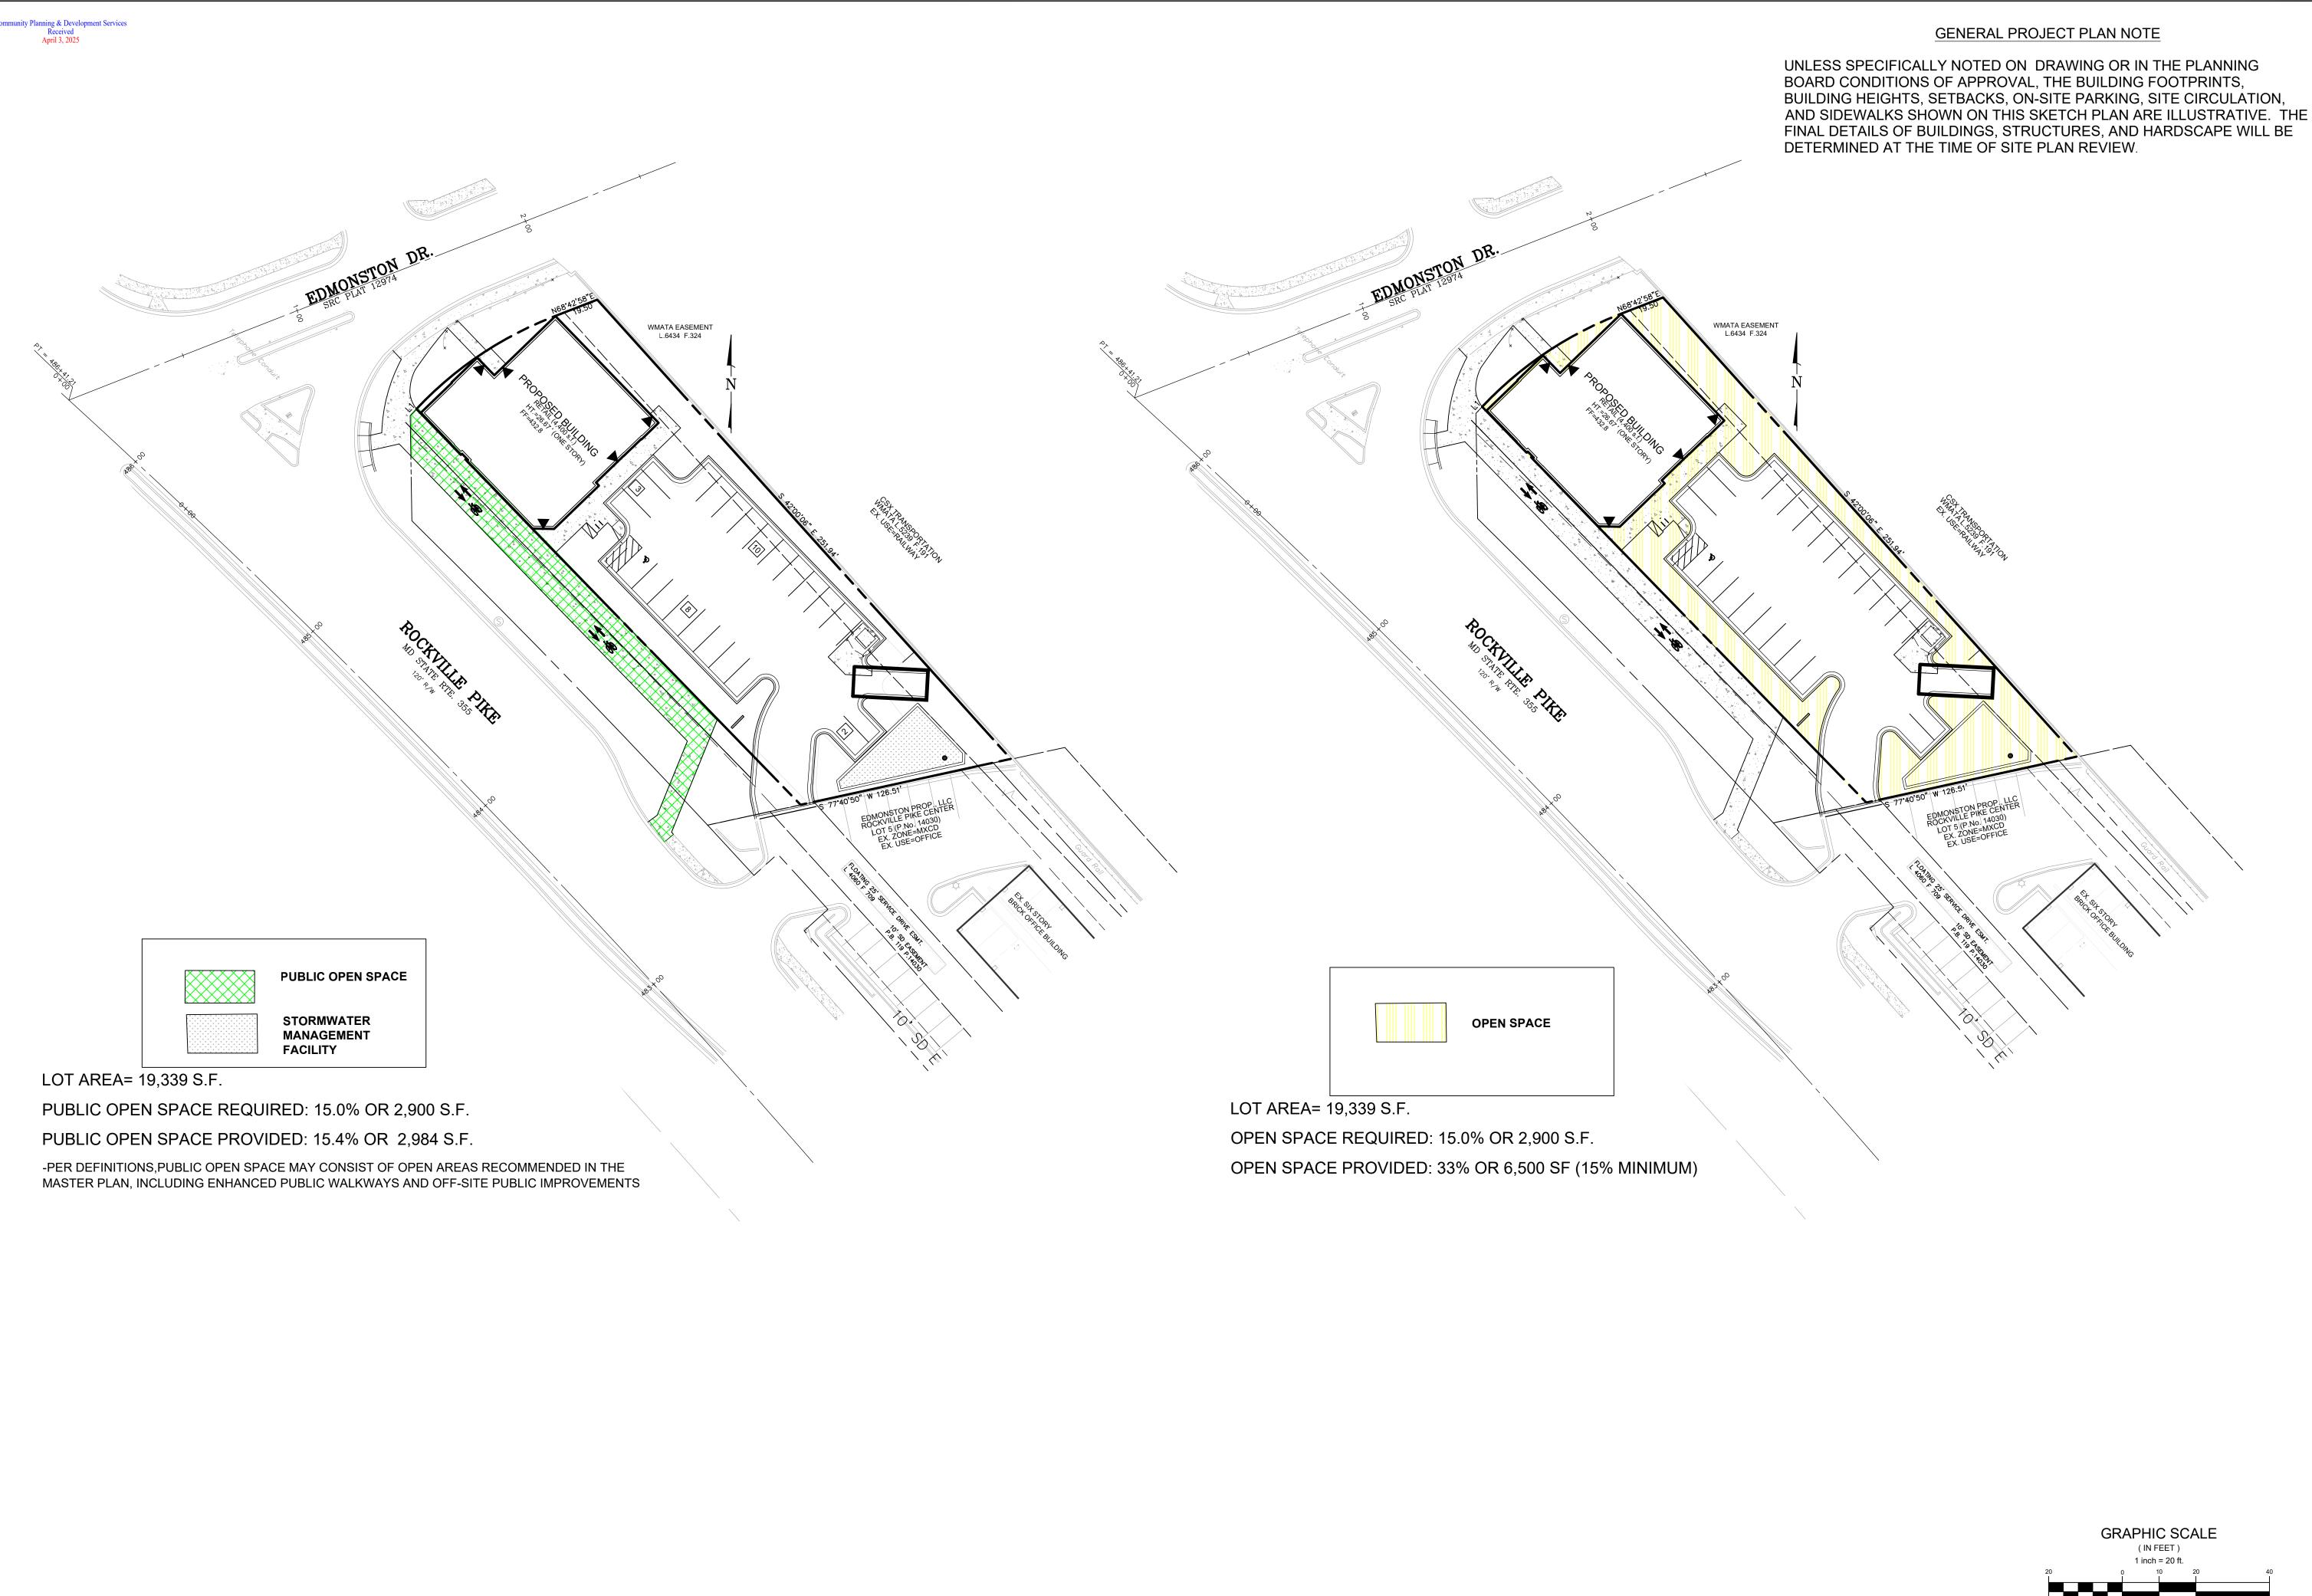



Civil Engineers
Land Planners

Land Planners

Landscape Architects

Land Surveyors

9220 Wightman Road, Suite 120 Montgomery Village, MD 20886 Phone: 301.670.0840 www.mhgpa.com

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PProfessional Certification
hereby certify that these documents were prepared or ereby certify that these documents were prepared or approved by the and that a line and life the profession of the sale of or the sale of the

OWNER: J DANSHES, LLC 9213 WINTERSET DR POTOMAC, MD 20854 jdanshes@yahoo.com

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SUITE 700
BETHESDA, MD, 20814
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ATTORNEY:
MILLER, MILLER & CANBY
200-B MONROE STREET
ROCKVILLE, MD,
JODY KLINE
301-738-2051

REVISIONS

NO. DESCRIPTION DATE

SUBMIT PROJECT PLAN 12/14/2

TAX MAP GR561 WSSC 217NW06

L. 44329 F. 159

4TH ELECTION DISTRICT CITY OF ROCKVILLE MARYLAND

ST. MARY'S PARCEL P214

THE PIKE

PROJ. MGR DRAWN BY

DANSHES CENTER ON

 DRAWN BY
 BJD/KDJ

 SCALE
 1"= 20'


 DATE
 12/2022


PROJECT PLAN


SHEET NO.


OPEN SPACE AND GREEN AREA EXHIBIT

PROJECT NO. 2004.115.33

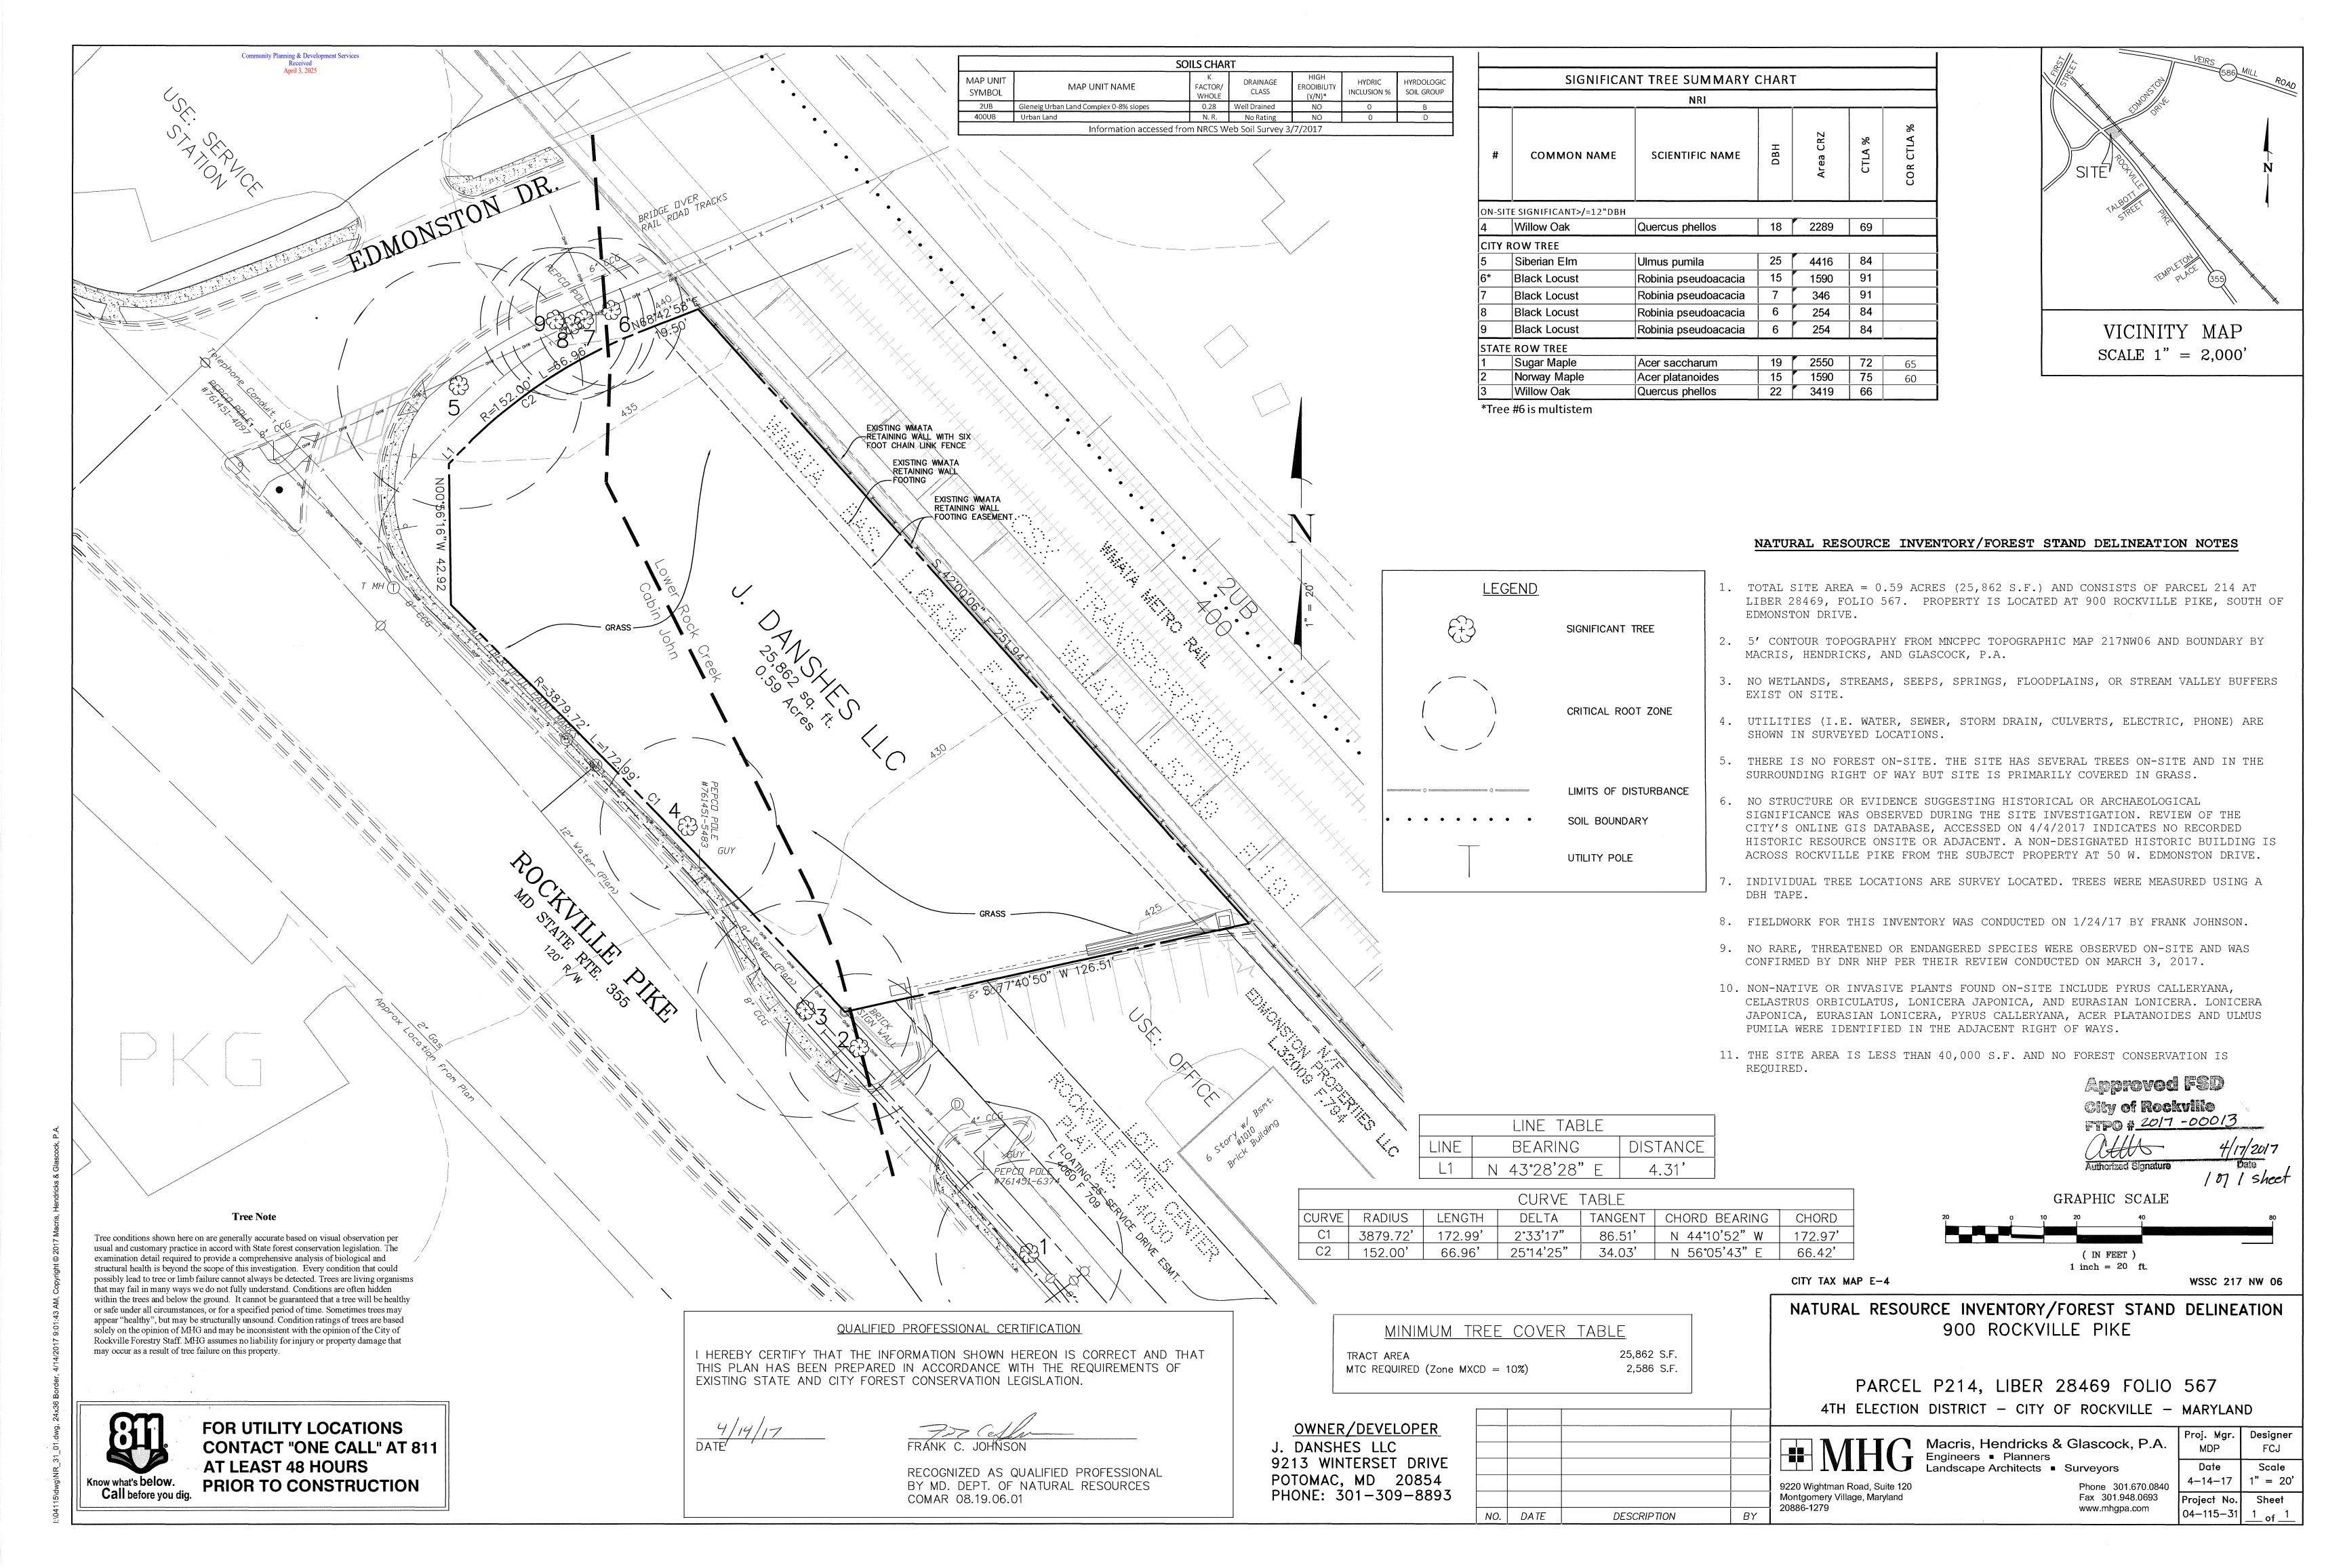

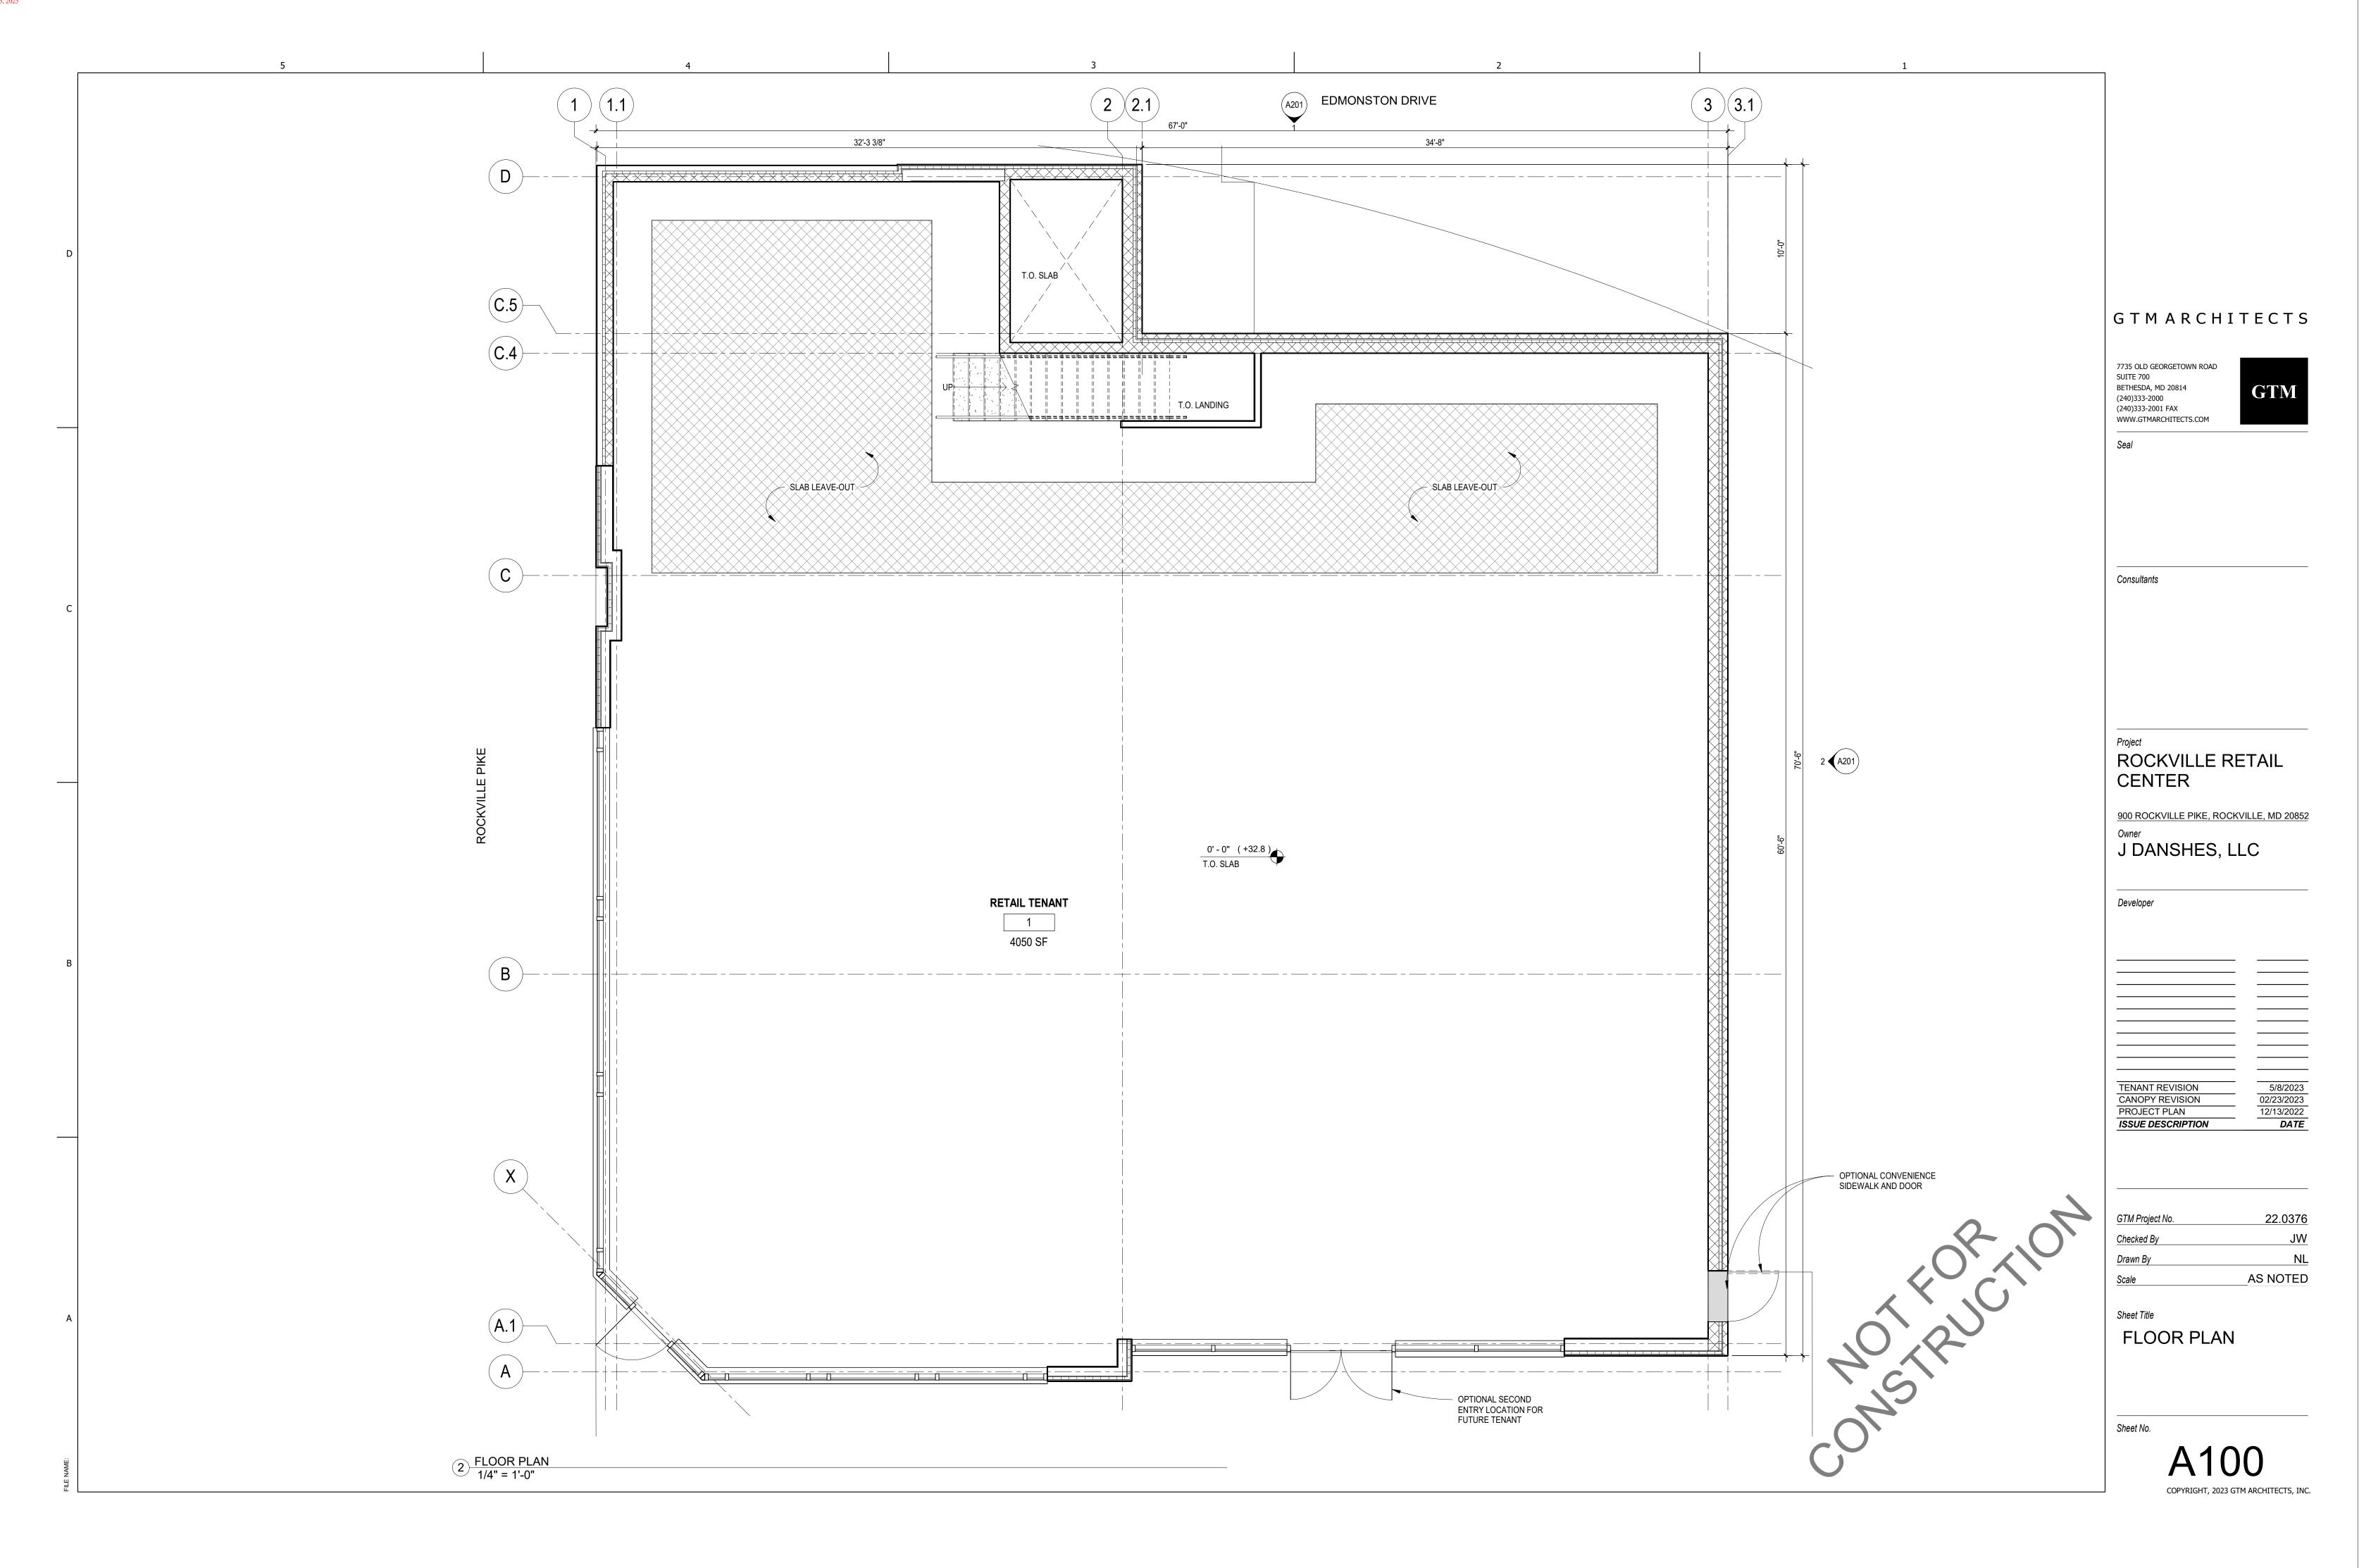

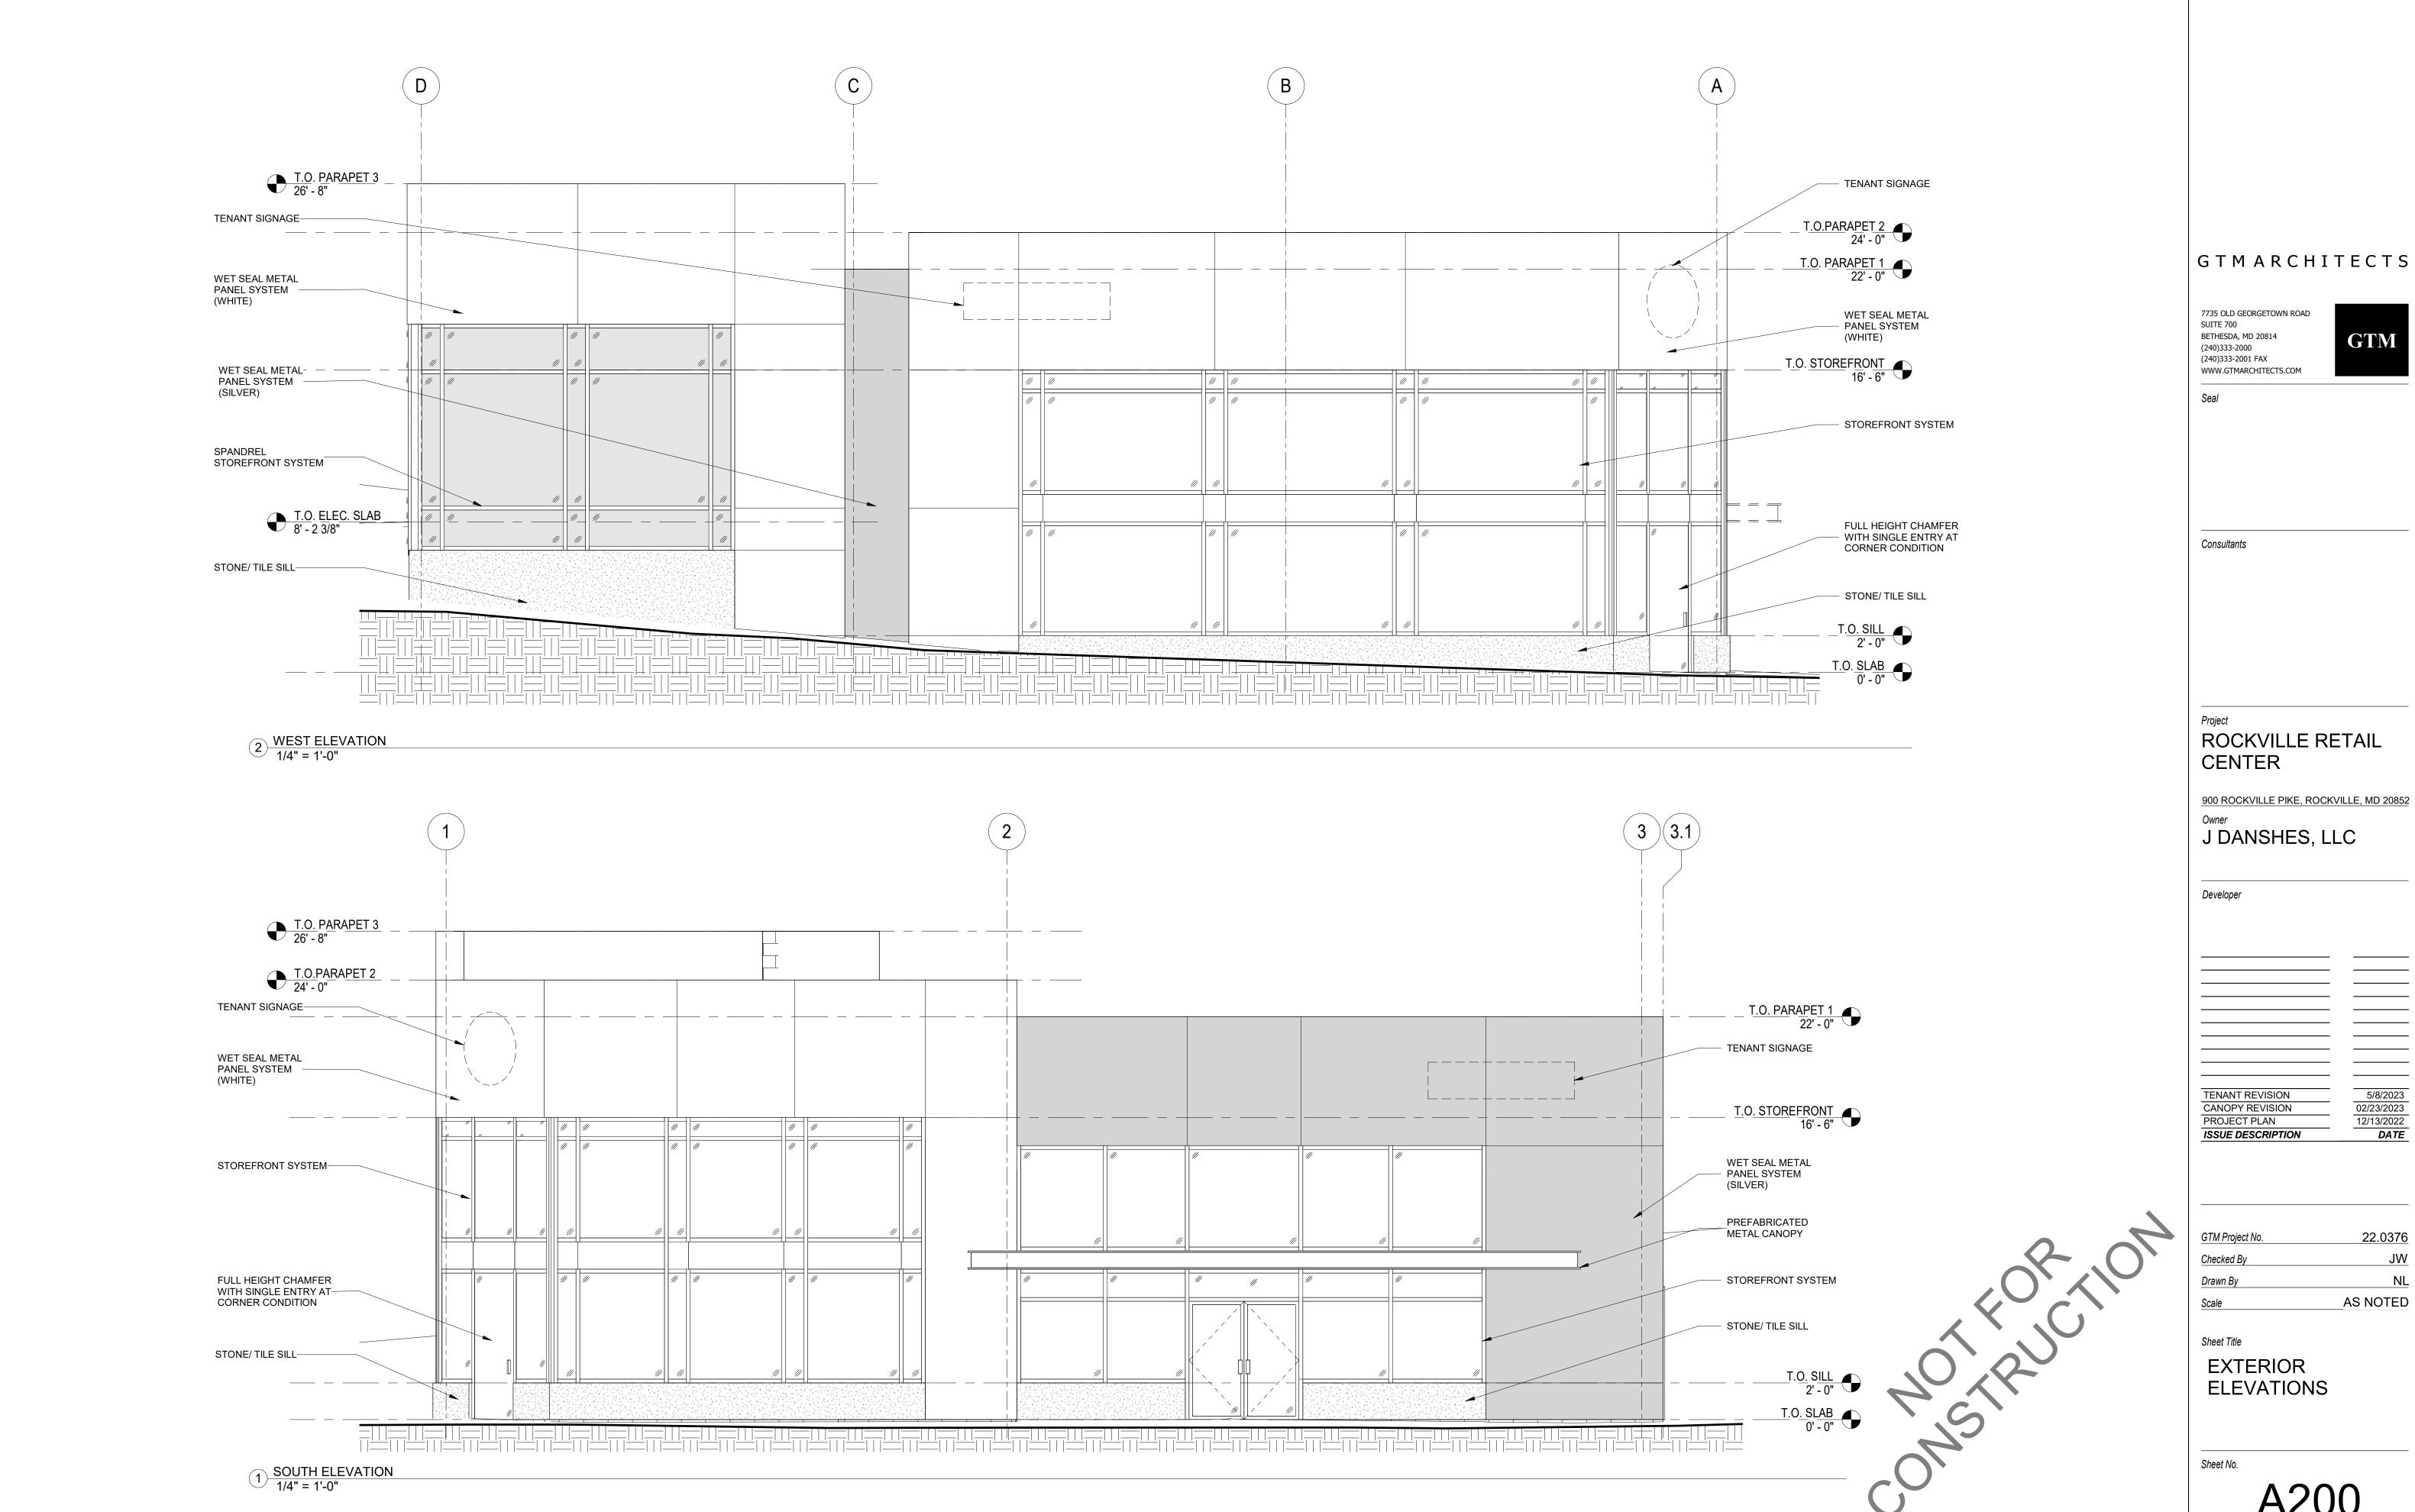

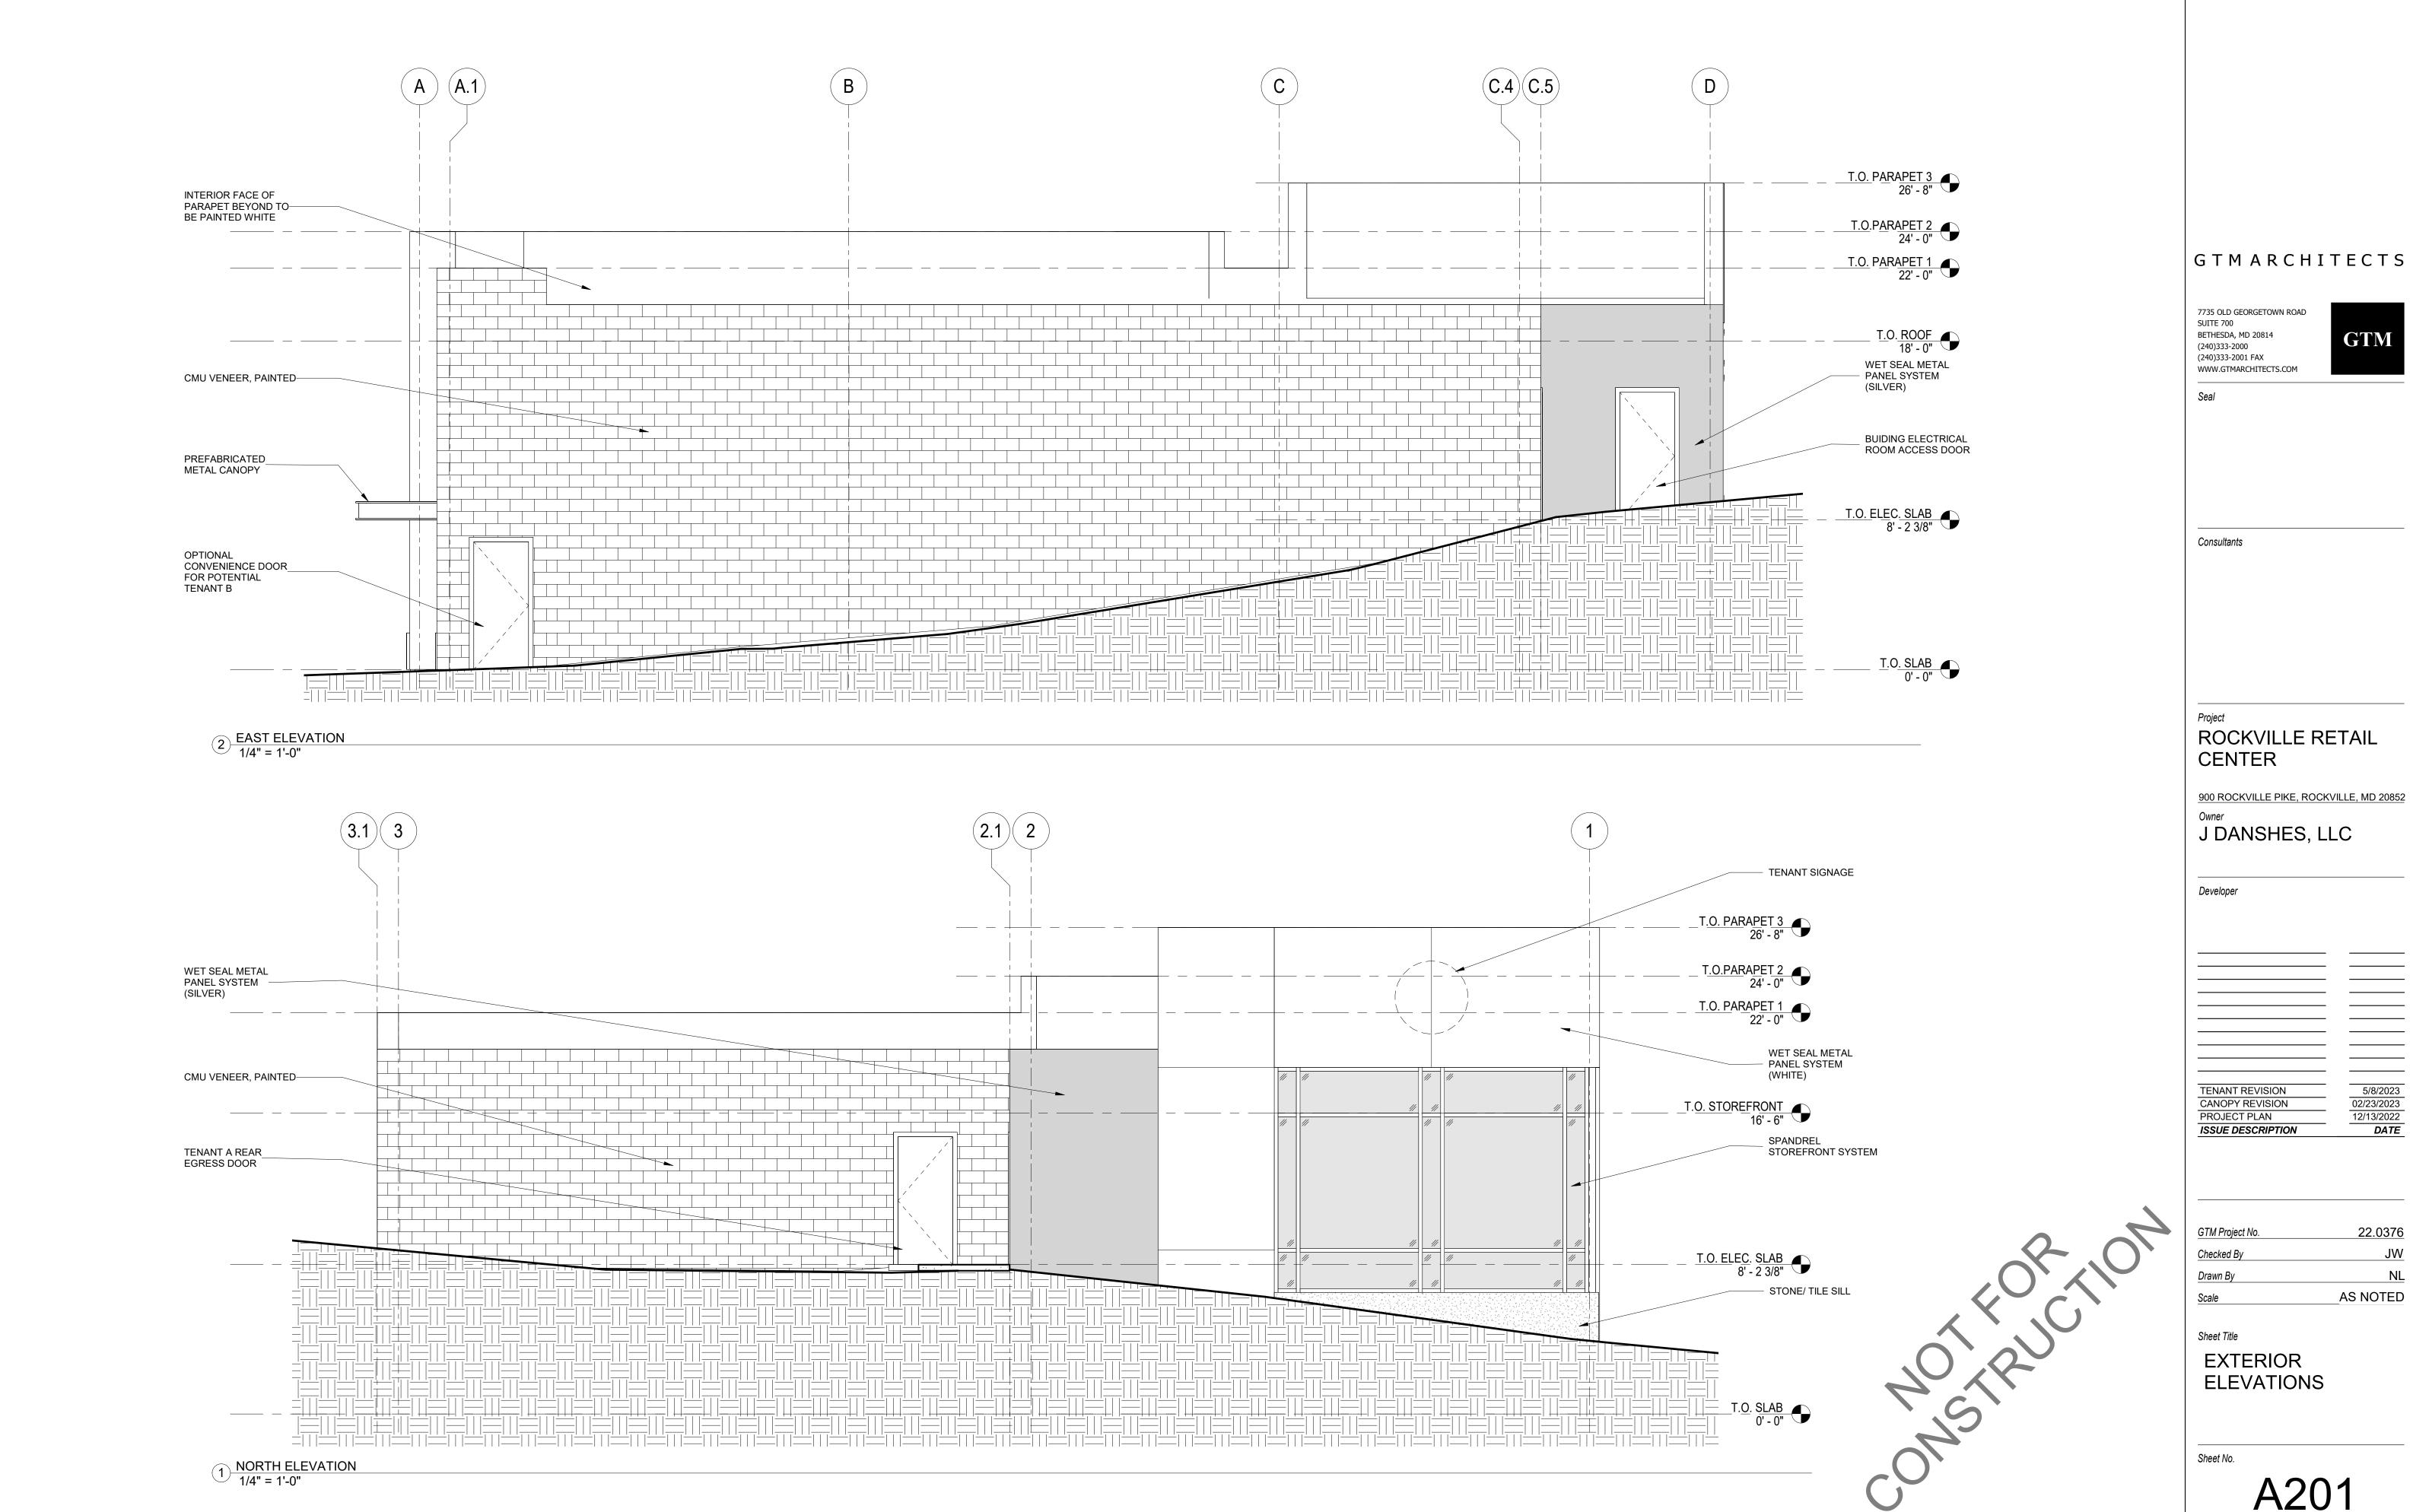

900 Rockville Pike PJT2023-00016 Project Plan Resubmission September, 2017 - Wells & Associates June, 2023 - Amended - Street Traffic Studies, Ltd

INTRODUCTION

Wells and Associates initially prepared a Transportation Statement for the project 900 Rockville Pike in 2017. Since that time, certain elements of the project have changed and the City has requested that the original study be amended to reflect those changes. Street Traffic Studies has completed those amendments to the original report while maintaining the original components that remain unchanged. All text changes made by Street Traffic Studies will be clearly identified by italic type.

The purpose of this report is to provide a limited Comprehensive Transportation Review for a project which will generate less than 30 peak hour trips during the AM, PM and Saturday peak hours of the adjacent street system. This report has been prepared in accordance with the March 21, 2011 CTR Methodology and through correspondence with City of Rockville Staff. Staff Correspondence is contained in Exhibit A.

The project, 900 Rockville Pike, is located along the east side of MD 355 (Rockville Pike) at the south-east corner of MD 355 (Rockville Pike)/Edmonston Drive Intersection as shown in Figure 1 below.

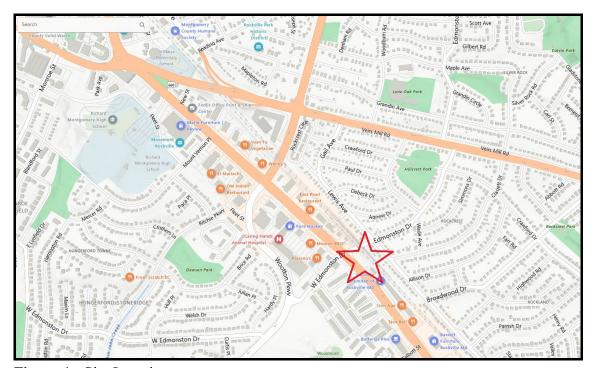


Figure 1 - Site Location

900 Rockville Pike PJT2023-00016 Project Plan Resubmission Revised June 2023 Page Two

The site is an unimproved vacant parcel located outside of a Transit Oriented Area (TOA), as defined in the City of Rockville Comprehensive Transportation Review Methodology.

900 Rockville Pike will, if approved, consist of the following mix of uses:

Land Use - Commercial Retail

Total 4,400 square feet

A development plan for the site was previously approved in 2006 for a 12,574 square foot furniture store. Details of this approval are summarized in Resolution 14-06. Subsequent to the approval, the City, the County and the MSHA have studied the design option to upgrade MD 355 within the City, to accommodate the future needs including the planned Bus Rapid Transit line.

The project Statement of Justification provides the full details of the history of that work but the following discussion details the current status as it impacts the subject property:

City planners and Public Works officials have advised the Applicant that SHA and MCDOT have finally concluded that the necessary width of Rockville Pike on the east side of the roadway adjacent to the subject property must be at least 93 feet from the centerline of the Pike. Within that distance must be located; a) three through drive lanes on the Pike, b) a right turn lane to eastbound Edmonston Drive, c) an 8 foot wide "cycle track", and d) a 7 foot wide sidewalk. Items © and (d) comprise a 15 foot "shared use path".

Since that time the design of the northbound MD 355 right turn lane at its intersection with Edmonston Road has been further refined. The decision has been made that the separate right turn lane would remain, however the existing features of a sweeping hot lane would not be provided. Due to the planned cycle track on the east side of MD 355, the operational concerns of the right turn lane require that it function as a signalized right turn movement, with no free right turns or right turn on red movements allowed. The design of the right turn lane will need to ensure that the geometry needs of truck turning movements are safely accommodated.

900 Rockville Pike PJT2023-00016 Project Plan Resubmission Revised June 2023 Page Three

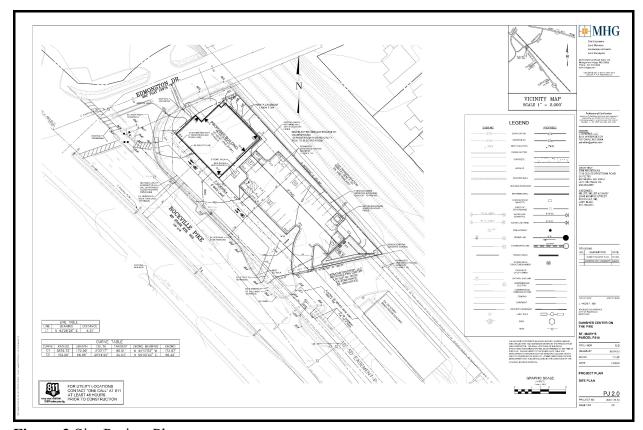


Figure 2 Site Project Plan

The Site Project Plan shown in Figure 2 above presents the proposed commercial office building, parking lot, and access drive adjusted to reflect the impact of the 93 foot offset from centerline for the future MD 355 and BRT upgrades.

VEHICLE TRIP GENERATION

The peak hour vehicle trips that would be generated by the 900 Rockville project were estimated using the trip generation rates/equations published by the Institute of Transportation Engineers (ITE) Trip Generation Manual, 11th Edition. The trip generation for the proposed land uses is shown in Table 1 on the following page.

As noted in the table, a reduction in peak hour trips was applied to both the morning and evening peak hours to reflect the previously approved 12,579 square foot furniture store, previously approved for the site, as summarized in Resolution 14-06, for PPD 2006-00011.

900 Rockville Pike PJT2023-00016 Project Plan Resubmission Revised June 2023 Page Four

For consistency purposes, 11th ITE Trip Generation rates were applied for both the previous approval and the new proposed use. In both cases, average trips rates were used for both the morning and evening peak hours.

TABLE 1 TRIP GENERATION STUDY						
Development Morning Peak Hour Evening Peak Hour					Hour	
	In	Out	Total	In	Out	Total
900 Rockville Pike Trips/ 4,400 sf retail	6	4	10	14	15	29
Previous approval (Resolution 14-06) Trips/12,574 Furniture Store	2	1	3	3	4	7
Net New Trips	4	3	7	11	11	22

ITE 11th Edition Trip Generation Manual used for all uses LU Code 822 - Shopping Center less than 40,000 sf LU Code 890 - Furniture Store

The average rate was used to calculate the trip generation for all peak hours.

As shown in Table 1, the project will generate 7 AM new peak hour trips, 22 PM new peak hour trips. As shown, the proposed development will generate fewer than 30 peak hour trips during the AM, PM periods. Therefore, a full CTR study is not required for the subject development.

900 Rockville Pike PJT2023-00016 Project Plan Resubmission Revised June 2023 Page Five

SITE ACCESS AND CIRCULATION

This section presents a proposed site access and circulation transportation statement and the proposed conditions site plan. Auto and non-auto site access and circulation are evaluated in this component.

PROPOSED SITE ACCESS AND CIRCULATION TRANSPORTATION STATEMENT

The Site Plan presented in *Figure 2* shows the planned site features, which comply with City codes, standards, and policies.

The property is in proximity to an existing diverse transportation network that includes, bus, bicycle, and pedestrian facilities and services.

Hours of Operation and Other Services. It is anticipated that the hours of deliveries, pick-ups, and other services to the building at 900 Rockville Pike would be typical of other such buildings in the City of Rockville. Because of the relatively small size of the proposed building it is expected that truck deliveries will be made by a typical Single Unit Truck, referred to as a SU- 30 design vehicle. Additionally, as is typical of a building of this size and nature, deliveries are typically scheduled during the "off-Peak" hours to minimize conflicts with customer access and parking.

Design Vehicles. The proposed site plan is designed to adequately accommodate all types of vehicles anticipated to access the site, including automobiles, delivery vehicles, trash trucks, taxis, motorcycles, and bicycles. Autoturn vehicle turning movement studies have been completed by the project engineer and are included in the submission packager demonstrating the expected truck turning movements both on the site and through the site access to MD 355.

Pedestrian Facilities. The information provided on the City of Rockville website indicates that sidewalks are currently provided along the property frontage on MD 355 (Rockville Pike) and on the northern end of the property on Edmonston Drive. As shown on Figure 2, the Site Project Plan, a 7 foot sidewalk is planned along the length of the MD 355 frontage, that will ultimately be part of the overall enhanced pedestrian network serving not just MD 355 but also a critical link to the planned BRT, with a station planned to be located in the median of MD 355, directly opposite the subject site.


Bicycle Facilities. The information provided on the City of Rockville website indicates that signed-shared roadway bicycle paths exist along Edmonston Drive and extends from Baltimore Road to Wootton Parkway. A copy of the bicycle routes and paths in the study area in included in Exhibit D.

900 Rockville Pike PJT2023-00016 Project Plan Resubmission Revised June 2023 Page Six

As shown on Figure 2, the Site Project Plan, a 8 foot - 2 way cycle track is planned along the length of the MD 355 frontage, that will ultimately be part of the overall enhanced pedestrian network serving not just MD 355 but also a critical link to the planned BRT, with a station planned to be located in the median of MD 355, directly opposite the subject site.

Public Transportation Facilities and Services. The subject site currently is served by two (2) Ride-On bus routes in the immediate vicinity.

The two Ride-On Bus routes offer service in Rockville:

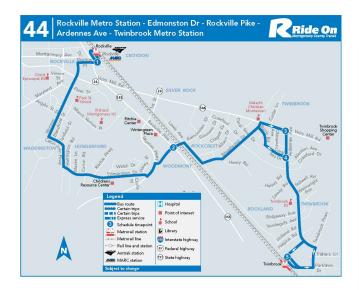



From Twinbrook Metro Station to Rockville Metro Station- five days a week Shady Grove Metro to Medical Center - seven days a week

Based on recent discussions with Montgomery County project designers, the BRT design, which begins at the Bethesda Metro Station and extends north to Germantown is currently at the 35% design stage. The northern section which begins at Montgomery College is currently funded for construction; efforts are underway to secure the funding for the southern section. Current plans are for construction to begin in 2025 / 2026.

900 Rockville Pike PJT2023-00016 Project Plan Resubmission Revised June 2023 Page Seven

PROPOSED CONDITIONS SITE PLAN

Auto Site Access. As shown on site plan included in *Figure 2*, 900 Rockville Pike will be served by a shared access driveway located *along the east side of MD 355(Rockville Pike)*. The site entrance will be a right-in, right-out access only, and will operate under a stop sign control.

SUMMARY

900 Rockville Pike is located along the east side of MD 355 (Rockville Pike) at the south-east corner of MD 355 (Rockville Pike)/ Edmonston Drive Intersection. The property is currently unimproved and applicant proposes a development *comprising 4,400 SF of commercial retail space*.

The report has been prepared in accordance with the Comprehensive Transportation Review Methodology, but is limited to a discussion of only 2 of the components as required by the Comprehensive Transportation Review guidelines, and as discussed with City of Rockville staff. Vehicular access to the facility is provided via a shared driveway along MD 355(Rockville Pike),


Sidewalks currently exist on the property's frontage along MD 355(Rockville Pike) and north of the property on Edmonston Drive. The site is also served by adequate transportation facilities transportation facilities. In brief, Ride On routes 44 and 46.

The site plan for the project has been modified to accommodate the design requirements for the upgrade of MD 355, including the planned BRT line. These design parameters as defined by the City planners, Public Works, SHA and MCDOT concluded that the necessary width of Rockville Pike on the east side of the roadway adjacent to the subject property must be at least 93 feet from the centerline of the Pike. Within that distance must be located; a) three through drive lanes on the Pike, b) a right turn lane to eastbound Edmonston Drive, c) an 8 foot wide "cycle track", and d) a 7 foot wide sidewalk. Items © and (d) comprise a 15 foot "shared use path".

The Site Concept Plan developed for the subject property is in complete compliance with these requirements.

A trip generation analysis was conducted using the rates established in the Institute of Transportation Engineers, Trip Generation Manual, 11th Edition. Based on the analysis conducted, 900 Rockville will generate 7 new AM peak hour trips, 22 PM new peak hour trips. Since the site will generate less than the 30 trip threshold, a more extensive traffic study is not required.

In summary, the proposed development will have no impact on the roadway network surrounding the site. Therefore, this report does not recommend any mitigation measures, nor does expansion of the site require any trip credits to offset the traffic impact.

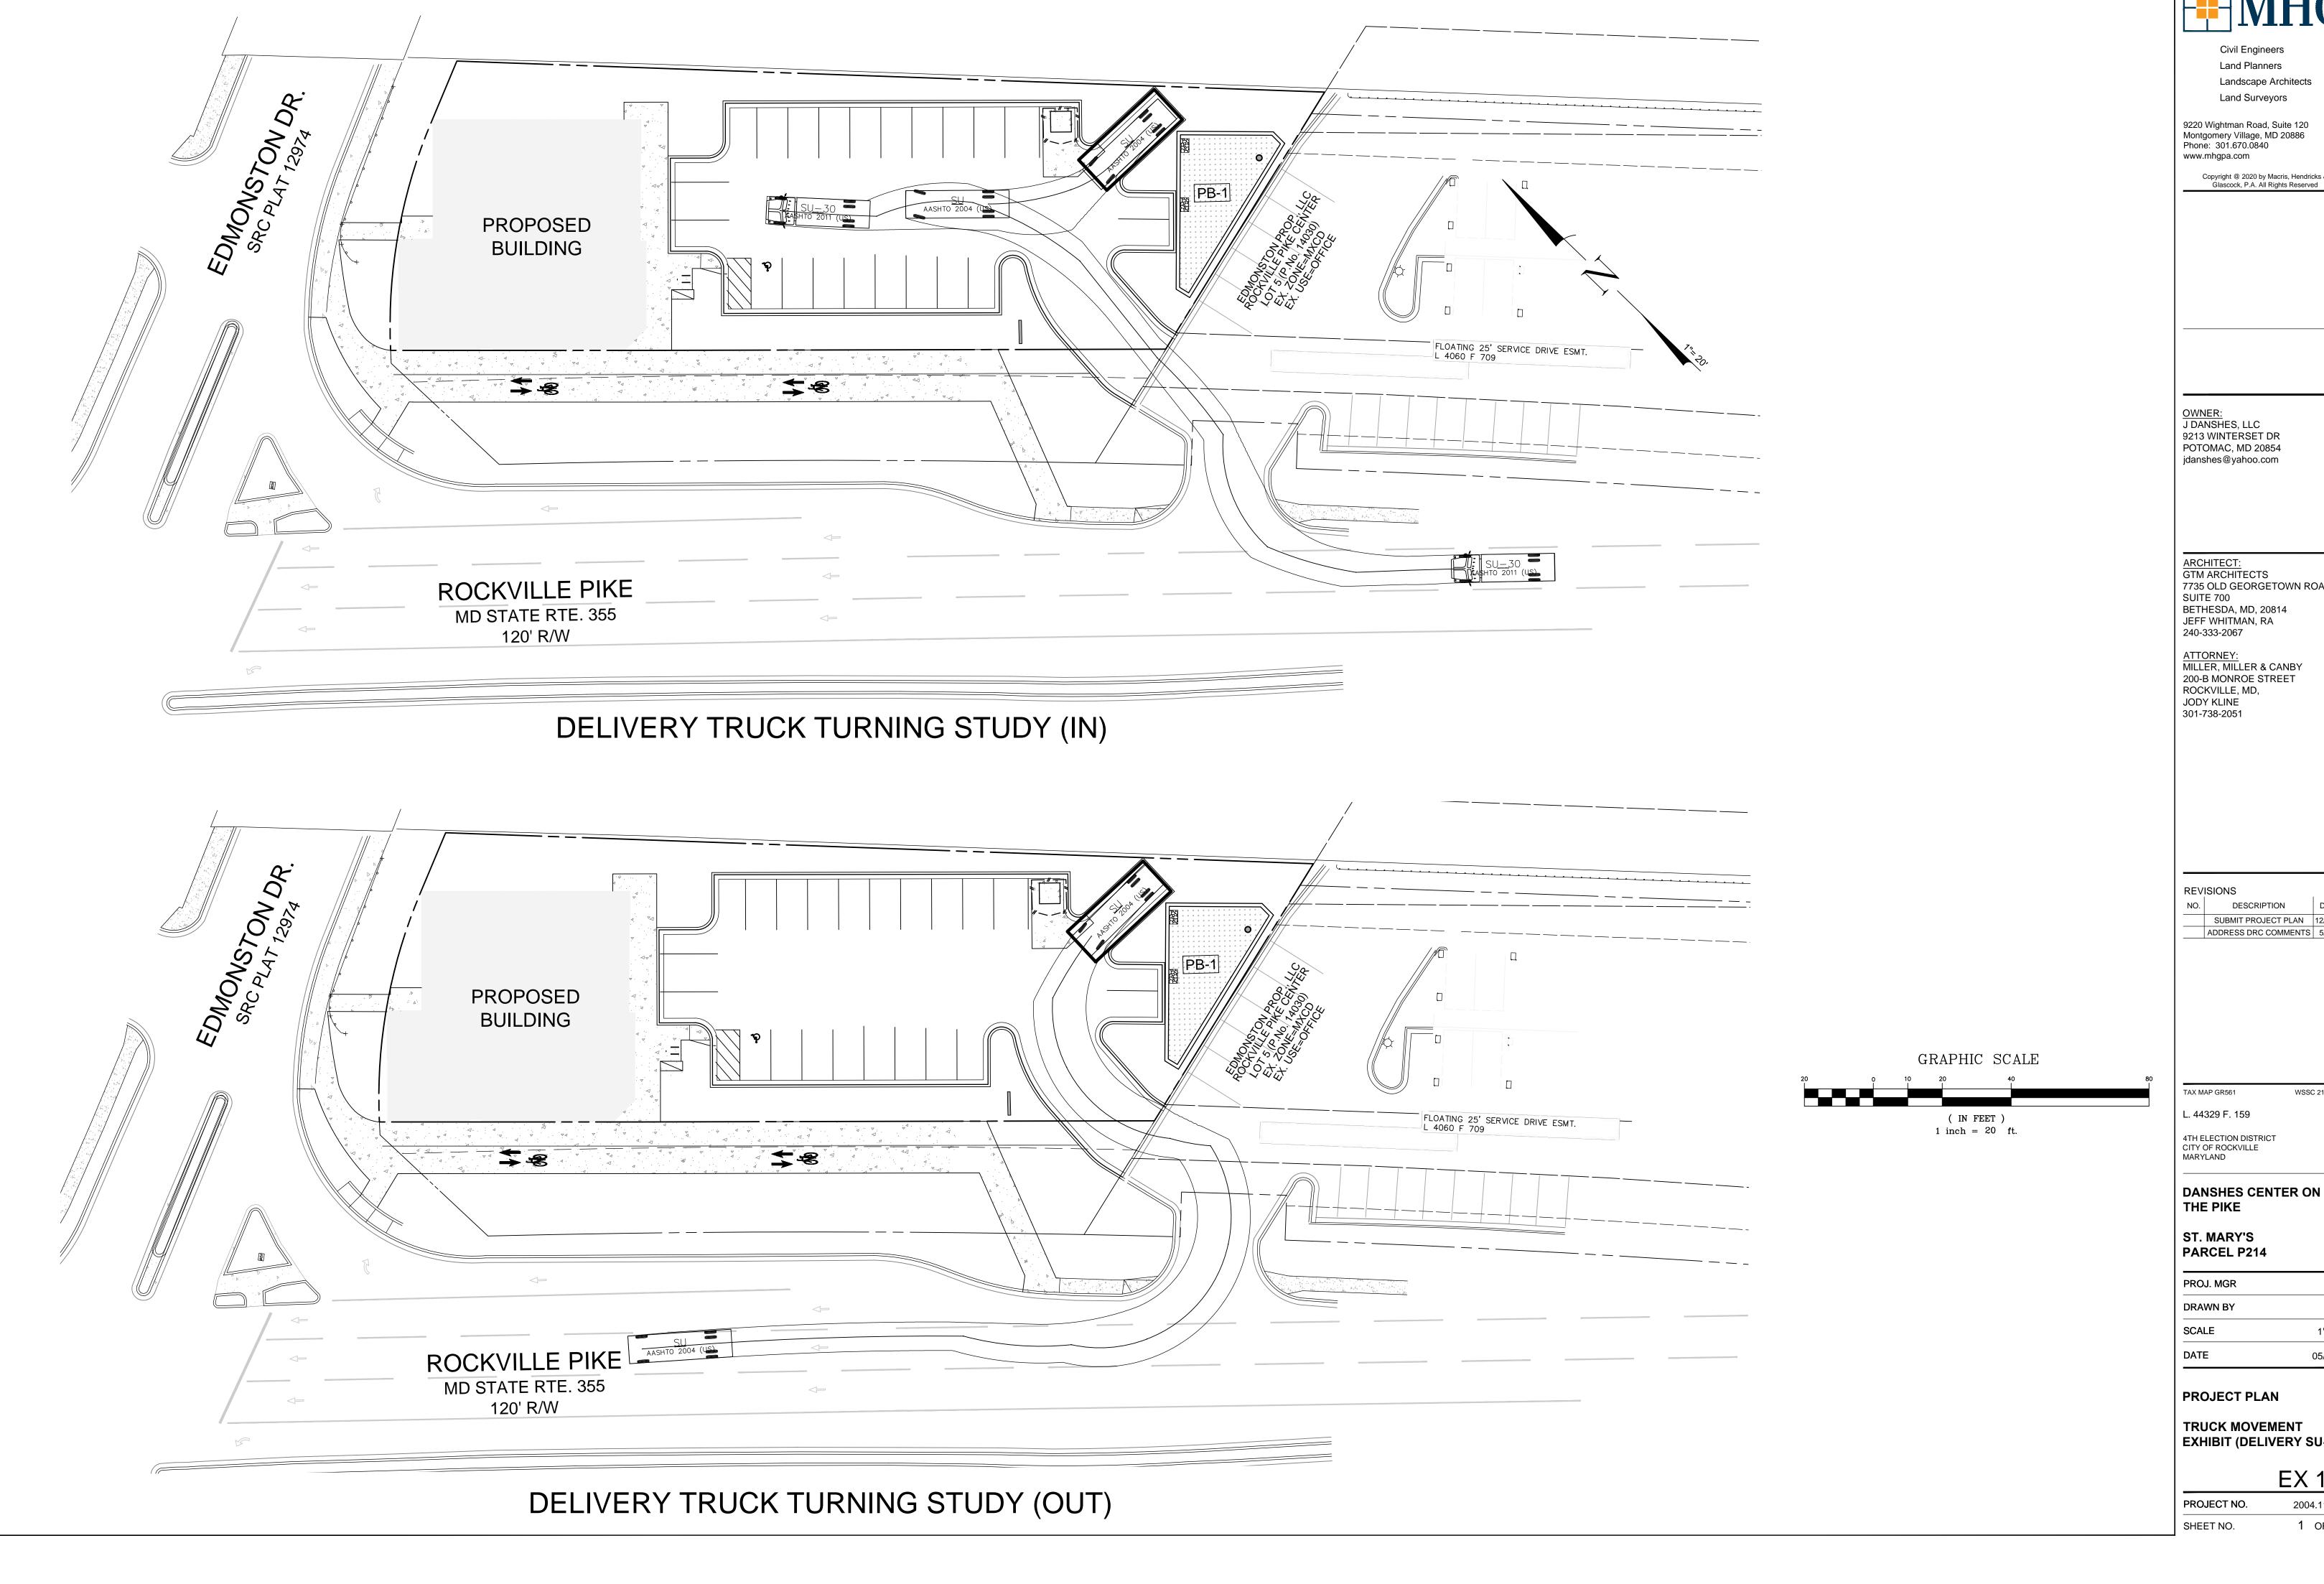

Land Planners Landscape Architects Land Surveyors

9220 Wightman Road, Suite 120 Montgomery Village, MD 20886 Phone: 301.670.0840 www.mhgpa.com

OWNER: J DANSHES, LLC 9213 WINTERSET DR POTOMAC, MD 20854

ARCHITECT:
GTM ARCHITECTS
7735 OLD GEORGETOWN ROAD SUITE 700 BETHESDA, MD, 20814 JEFF WHITMAN, RA

ATTORNEY:
MILLER, MILLER & CANBY
200-B MONROE STREET
ROCKVILLE, MD,
JODY KLINE
301-738-2051

REVISIONS

4TH ELECTION DISTRICT CITY OF ROCKVILLE MARYLAND

THE PIKE

ST. MARY'S PARCEL P214


PROJ. MGR	BJD
DRAWN BY	JDP
SCALE	1"= 20'
DATE	05/2023

PROJECT PLAN

TRUCK MOVEMENT EXHIBIT (DELIVERY SU-30)

EX 1.2

1 OF 1

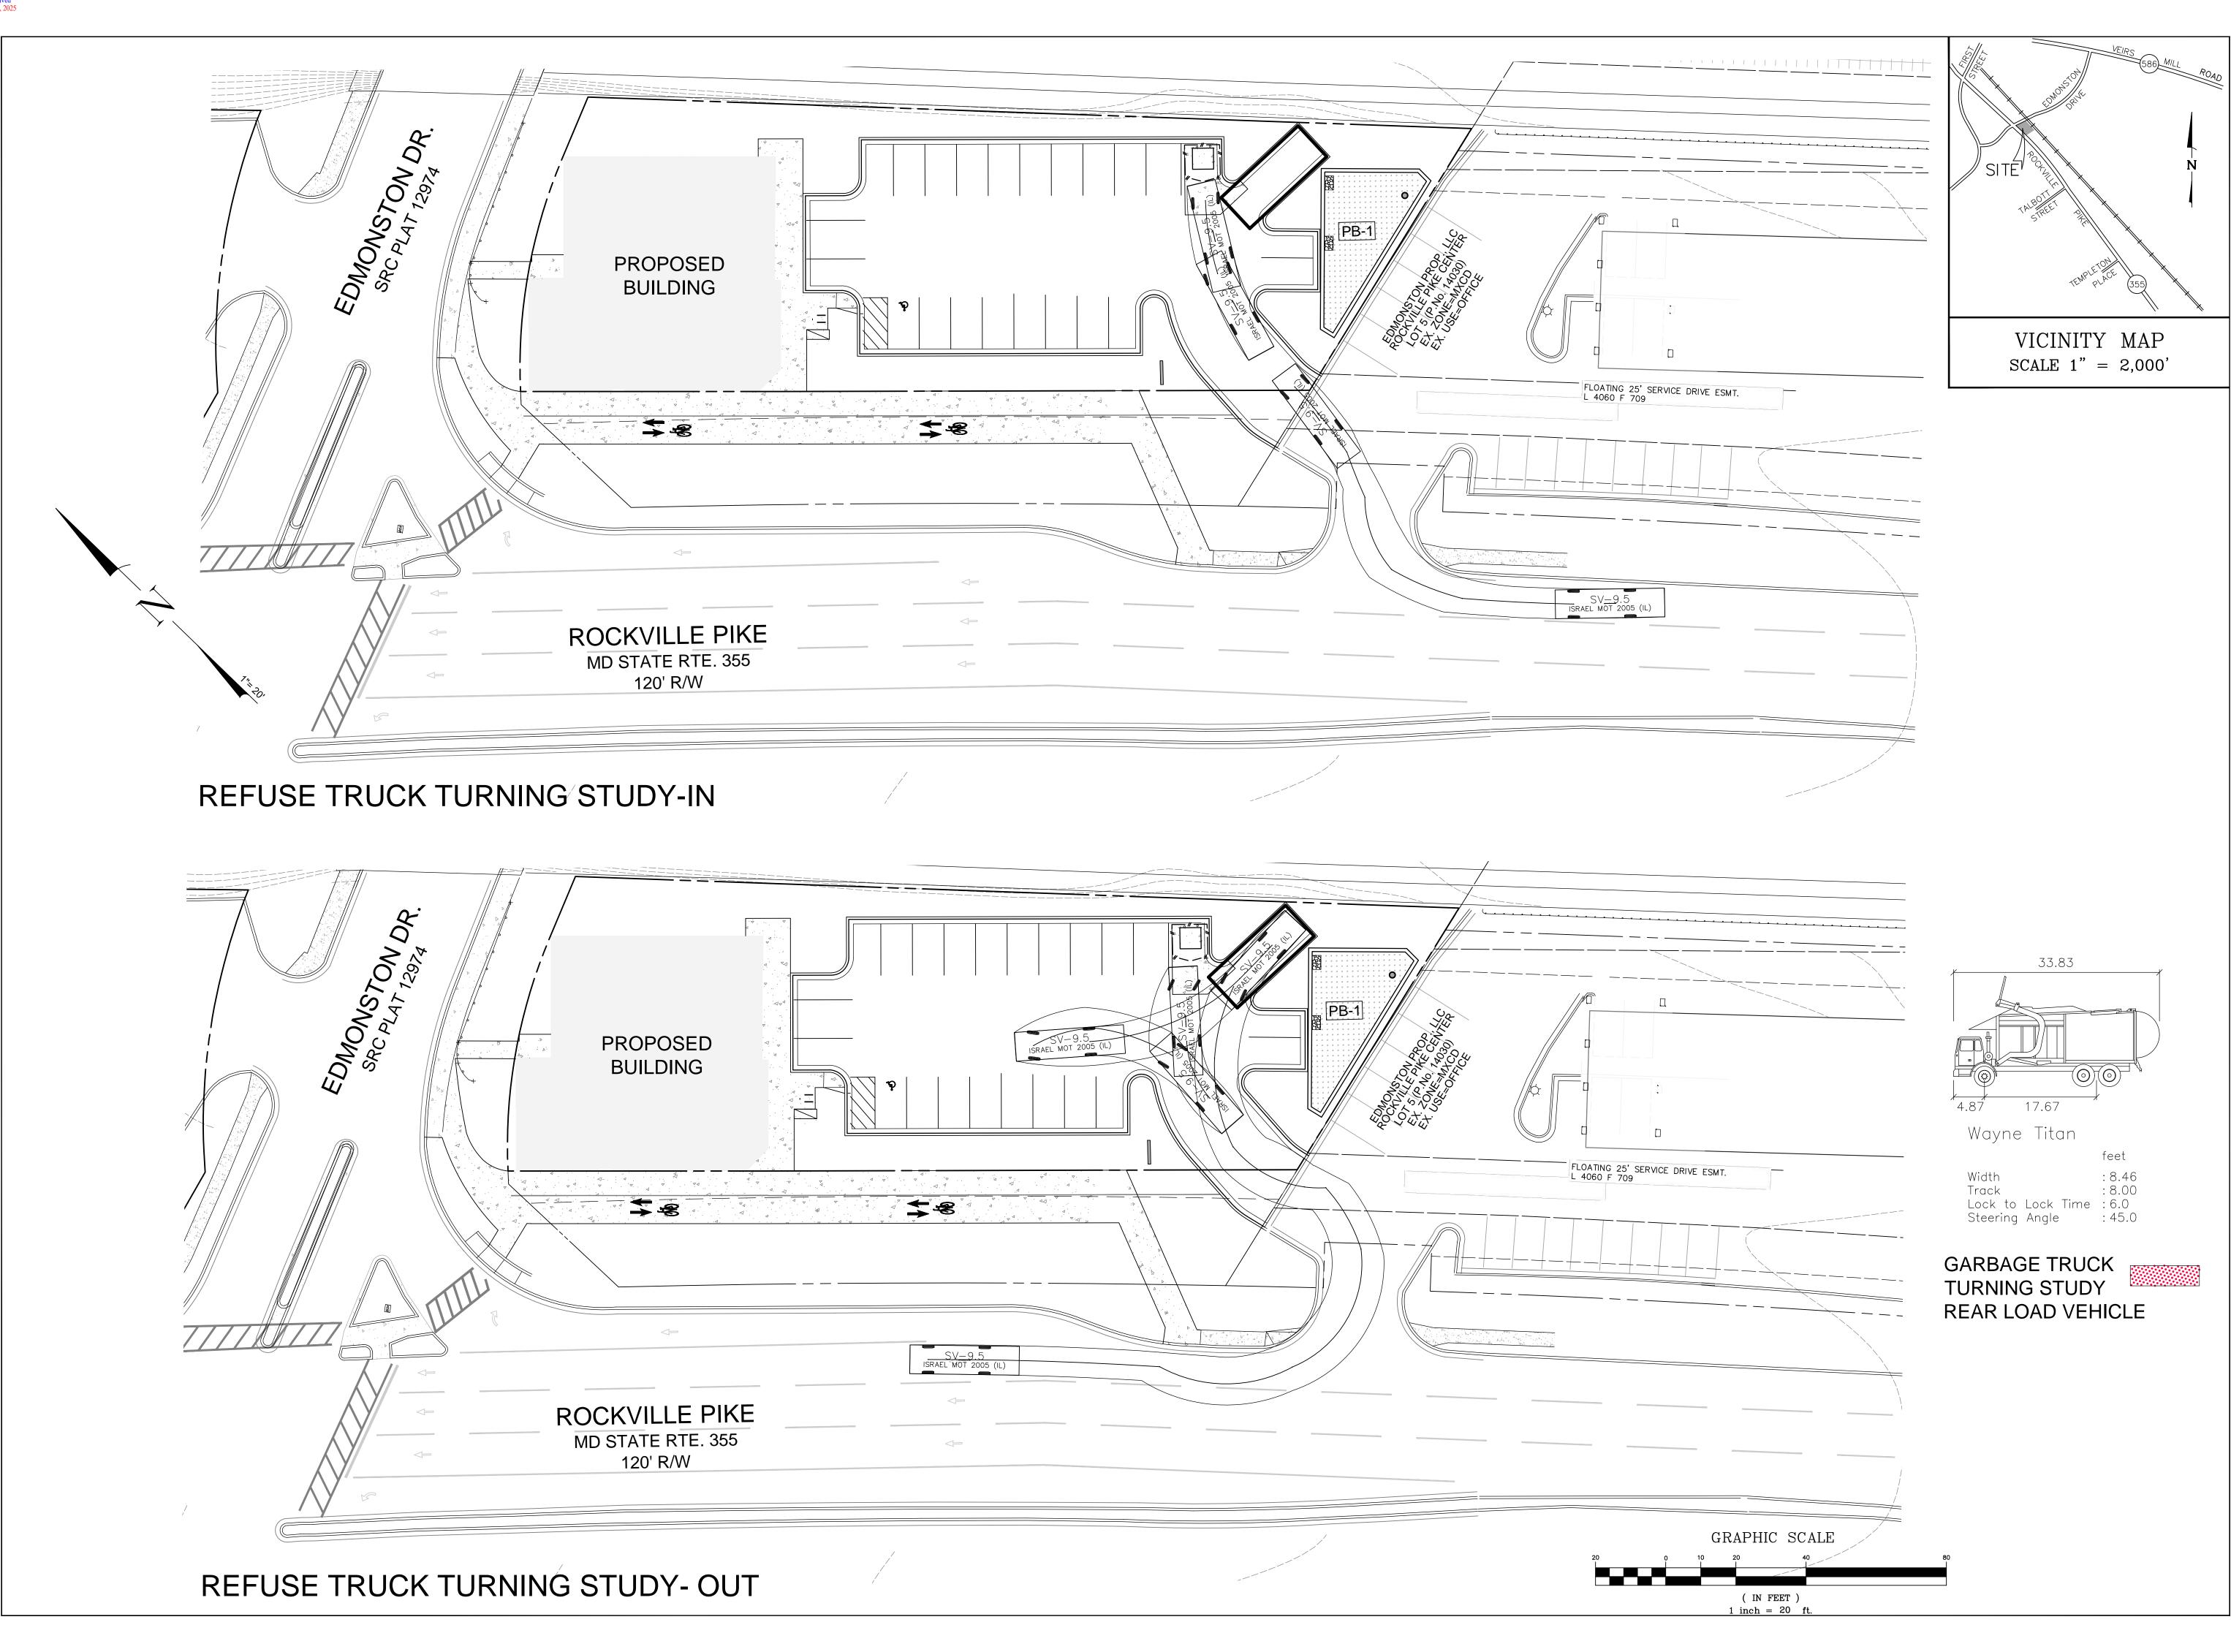

MH(

Civil Engineers

Land Planners

Land Surveyors

9220 Wightman Road, Suite 120
Montgomery Village, MD 20886
Phone: 301.670.0840
www.mhgpa.com

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Professional Certification

I hereby certify that these documents were prepared or approved by me, and that I am a duly licensed Professional Engineer under the Laws of the State of Maryland. Lic. No. 16905 Exp. Date. 04.21.2024

OWNER: J DANSHES, LLC 9213 WINTERSET DR POTOMAC, MD 20854 jdanshes@yahoo.com

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ATTORNEY:
MILLER, MILLER & CANBY
200-B MONROE STREET
ROCKVILLE, MD,
JODY KLINE
301-738-2051

EVISIONS

NO. DESCRIPTION DATE

SUBMIT PROJECT PLAN 12/13/2

ADDRESS DRC COMMENTS 5/8/32

MAP GR561 WSSC 217NW0

L. 44329 F. 159

4TH ELECTION DISTRICT
CITY OF ROCKVILLE
MARYLAND

DANSHES CENTER ON THE PIKE

ST. MARY'S PARCEL P214

 PROJ. MGR
 BJD

 DRAWN BY
 JDP

 SCALE
 1"= 20'

 DATE
 05/2023


PROJECT PLAN

SHEET NO.


TRUCK MOVEMENT EXHIBIT (REFUSE)


EX 1.1
PROJECT NO. 2004.115.33

1 of 1

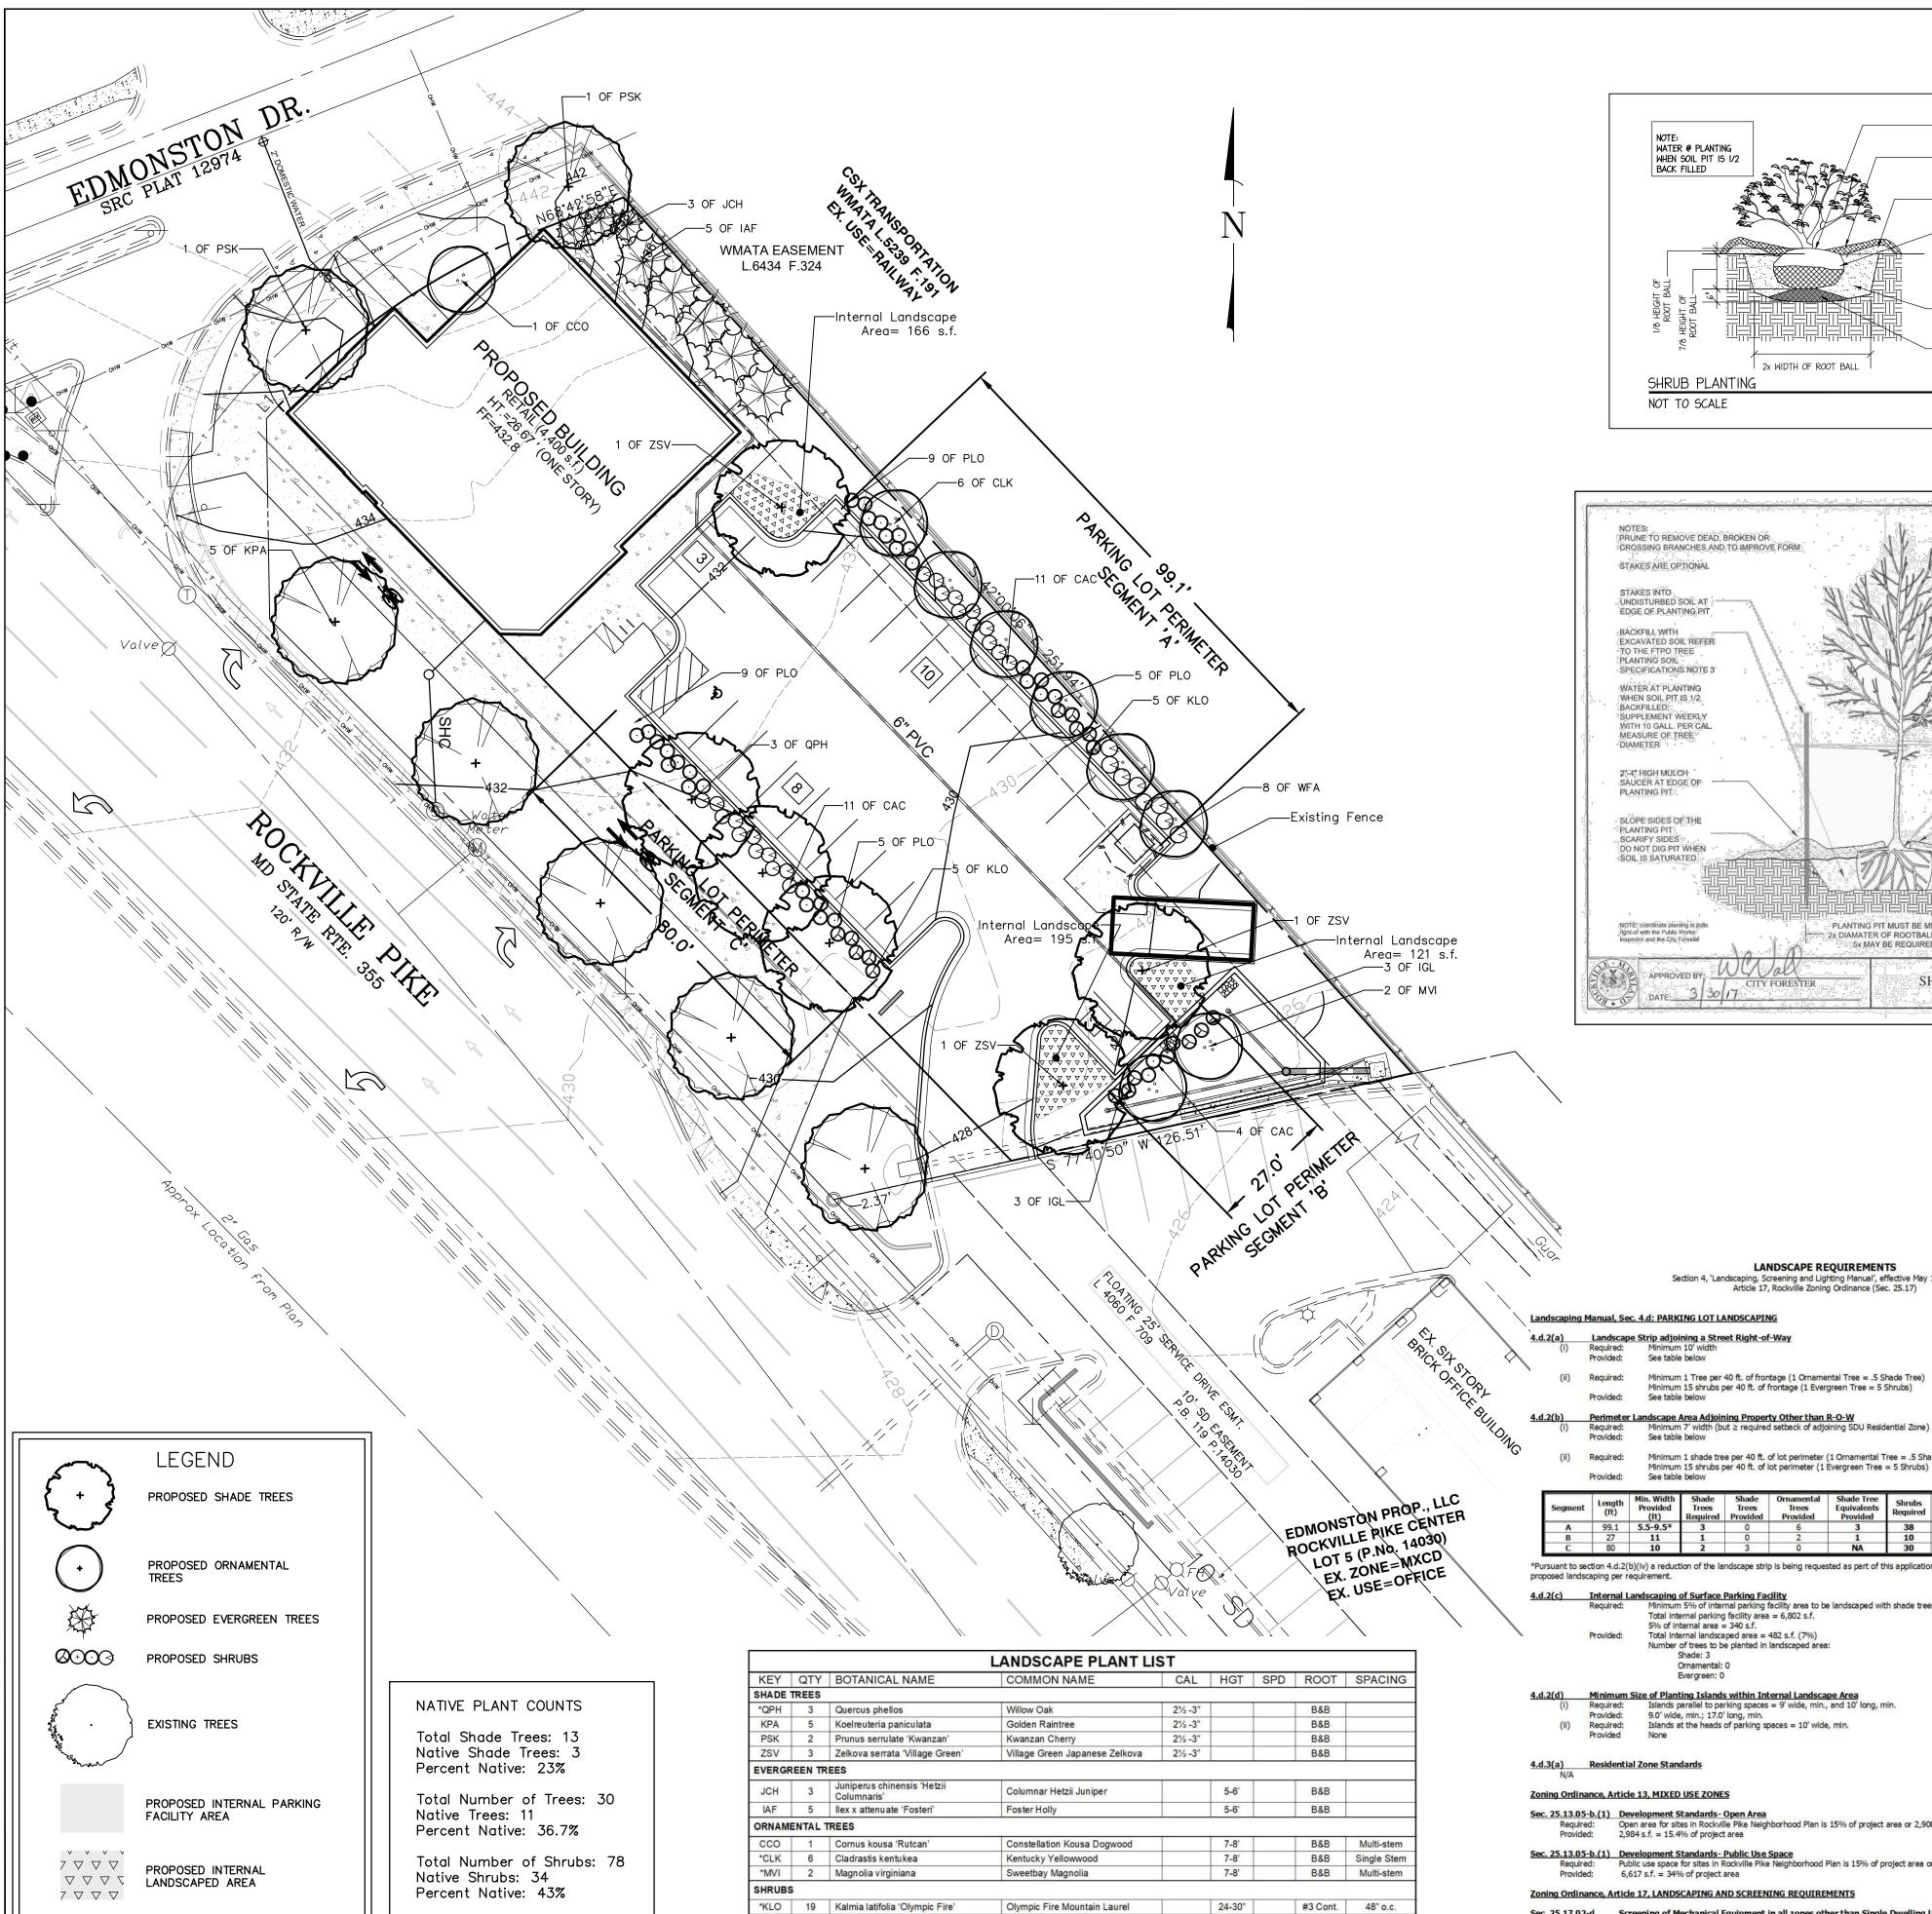

-PLACE TOP I/8 OF ROOT BALL ABOVE FINISH GRADE WATER @ PLANTING PINE BARK MULCH PLACE MIN. 2" DEEP WHEN SOIL PIT IS 1/2 OVER ENTIRE SAUCER AND RIM, EXCEPT LEAVE 2"-3" CLEAR AROUND TRUNK OR MAIN PLANT STEM CREATE 2"-3" SAUCER RIM WITH PREPARED SOIL MIX REMOVE BURLAP, TWINE, ROPE, WIRE ETC. FROM TOP 1/3 OF ROOT BALL. REMOVE SHRUB FROM ALL CONTAINERS AND VERTICALLY SLIT ROOT BALL WITH SHARP KNIFE EVERY 4"-6" AROUND BAL DO NOT LEAVE CIRCLING ROOTS AGAINST PLANTING SOIL PREPARED AS SPECIFIED TAMP AND WATER WHEN BACKFILLING EXCAVATE MIN. 6" BELOW BALL AND COMPACT PREPARED SOIL MIX AS BASE 2x WIDTH OF ROOT BALL SHRUB PLANTING NOT TO SCALE

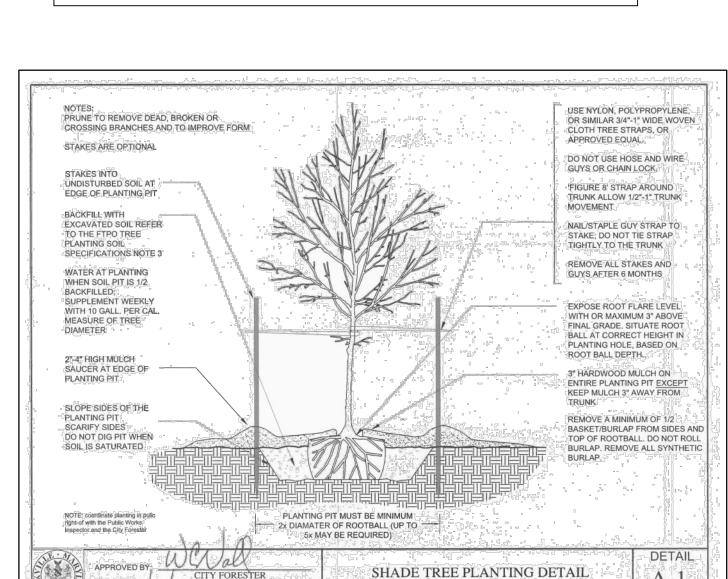

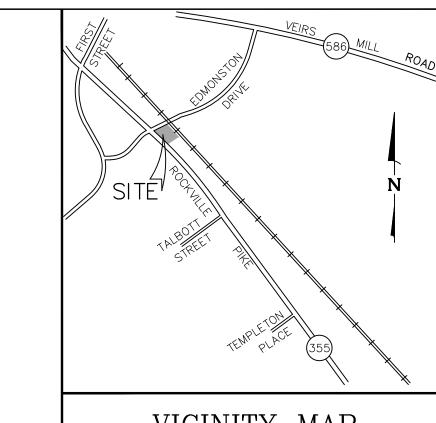

VICINITY MAP SCALE 1" = 2,000'USE NYLON POLYPROPYLEN OR SIMILAR 3/4"-1" WIDE WOVEN CLOTH TREE STRAPS, OR APPROVED EQUAL. DO NOT USE HOSE AND WIRE GUYS OR CHAIN LOCK. J DANSHES, LLC FIGURE 8' STRAP AROUND RUNK ALLOW 1/2"-1" TRUNK 9213 WINTERSET DR MOVEMENT POTOMAC, MD 20854 NAIL/STAPLE GUY STRAP TO

STAKE; DO NOT TIE STRAP

REMOVE ALL STAKES AN

GUYS AFTER 6 MONTHS

EXPOSE ROOT FLARE LEVE

WITH OR MAXIMUM 3" ABOVI

FINAL GRADE. SITUATE ROOT BALL AT CORRECT HEIGHT IN

PLANTING HOLE, BASED ON ROOT BALL DEPTH.

KEEP MULCH 3" AWAY FROM

REMOVE A MINIMUM OF 1/2

BASKET/BURLAP FROM SIDES

TOP OF ROOTBALL. DO NOT ROLL BURLAP, REMOVE ALL SYNTHETIC

3" HARDWOOD MULCH OF

GTM ARCHITECTS 7735 OLD GEORGETOWN ROAD SUITE 700 BETHESDA, MD, 20814

jdanshes@yahoo.com

Civil Engineers Land Planners

Land Surveyors

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Landscape Architects

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MILLER, MILLER & CANBY 200-B MONROE STREET ROCKVILLE, MD, JODY KLINE 301-738-2051

DESCRIPTION

_. 44329 F. 159

CITY OF ROCKVILLE

MARYLAND

THE PIKE

PROJ. MGR

DRAWN BY

SCALE

ST. MARY'S

PARCEL P214

4TH ELECTION DISTRICT

DANSHES CENTER ON

WSSC 217NW06

FCJ

1"= 20'

05.12.2023

JEFF WHITMAN, RA

240-333-2067

PLANTING NOTES

PLANTING PIT MUST BE MINIMUM

5x MAY BE REQUIRED)

EVERGREEN TREE PLANTING DETAIL

1. THIS PLAN IS FOR PLANTING PURPOSES ONLY.

CONTRACTOR SHALL BE SOLELY RESPONSIBLE FOR ALL PLANT MAINTENANCE, INCLUDING SHRUBS AND GROUNDCOVER, AND SHALL MAINTAIN AREA IN A WEED AND DEBRIS FREE

CONDITION, THROUGHOUT THE ONE YEAR GUARANTEE PERIOD. 3. CONTRACTOR SHALL LAY OUT AND CLEARLY STAKE ALL PROPOSED IMPROVEMENTS INCLUDED ON THIS PLAN.

APPROVED BY:

PRUNE TO REMOVE DEAD, BROKEN OR

STAKES ARE OPTIONAL

BACKFILL WITH

PLANTING SOIL

WATER AT PLANTING

MEASURE OF TREE

SAUCER AT EDGE OF

SLOPE SIDES OF THE

SOIL IS SATURATED

PLANTING PIT

WHEN SOIL PIT IS 1/2 BACKFILLED; SUPPLEMENT WEEKLY WITH 10 GALL: PER CAL.

EXCAVATED SOIL REFER. TO THE FTPO TREE

CONTRACTOR IS RESPONSIBLE FOR CONTACTING MISS UTILITY PRIOR TO BEGINNING CONSTRUCTION FOR LOCATION OF ALL UTILITY LINES. TREES SHALL BE LOCATED A MINIMUM OF 5 FEET FROM SEWER/WATER CONNECTIONS. CONTRACTOR SHALL BE LIABLE FOR DAMAGE TO ANY AND ALL PUBLIC OR PRIVATE UTILITIES.

QUANTITIES AS SHOWN ON THE PLAN SHALL GOVERN OVER PLANT LIST QUANTITIES. CONTRACTOR TO VERIFY PLANT LIST TOTALS WITH QUANTITIES SHOWN ON PLAN. LANDSCAPE ARCHITECT SHALL BE ALERTED BY CONTRACTOR OF ANY DISCREPANCIES PRIOR TO FINAL BID NEGOTIATION. UNIT PRICES FOR ALL MATERIAL SHALL BE SUPPLIED TO THE OWNER AT

ALL MATERIALS SHALL BE SUBJECT TO APPROVAL BY THE LANDSCAPE ARCHITECT. OWNER SHALL RECEIVE TAG FROM EACH PLANT SPECIES AND A LIST OF PLANT SUPPLIERS. WHERE ANY REQUIREMENTS ARE OMITTED FROM THE PLANT LIST, THE PLANTS FURNISHED SHALL MEET THE NORMAL REQUIREMENTS FOR THE VARIETY PER THE AMERICAN STANDARD FOR NURSERY STOCK, LATEST EDITION, PUBLISHED BY AMERICANHORT. PLANTS SHALL BE PRUNED PRIOR TO DELIVERY ONLY UPON THE APPROVAL OF THE LANDSCAPE ARCHITECT.

CONTRACTOR IS RESPONSIBLE FOR SOIL TESTING AND PREPARATION AS OUTLINED IN THE CURRENT EDITION OF THE LANDSCAPE SPECIFICATION GUIDELINES OF THE LANDSCAPE CONTRACTORS ASSOCIATION OF MD-DC-VA (LCA). PREPARATION SHALL INCLUDE, BUT NOT NECESSARILY BE LIMITED TO, THE ADDITION OF SOIL AMENDMENTS, FERTILIZERS AND SUPPLEMENTAL TOPSOIL AS INDICATED BY TESTING; AND SUBGRADE, FINAL GRADE AND FINISH GRADE SOIL PREPARATION.

8. WHERE TREES ARE PLANTED IN ROWS, THEY SHALL BE UNIFORM IN SIZE AND SHAPE.

SIZES SPECIFIED IN THE PLANT LIST ARE MINIMUM SIZES TO WHICH THE PLANTS ARE TO BE JUDGED. FAILURE TO MEET MINIMUM SIZE ON ANY PLANT WILL RESULT IN REJECTION OF

10. ALL PLANTS SHALL BE FRESHLY DUG, SOUND, HEALTHY, VIGOROUS, WELL BRANCHED, FREE OF DISEASE, INSECT EGGS, AND LARVAE, AND SHALL HAVE ADEQUATE ROOT SYSTEMS. L ALL CONTAINER GROWN MATERIAL SHALL BE HEALTHY, VIGOROUS, WELL-ROOTED PLANTS AND ESTABLISHED IN THE CONTAINER IN WHICH THEY ARE SOLD. THE PLANTS SHALL HAVE TOPS WHICH ARE GOOD QUALITY AND ARE IN A HEALTHY GROWING CONDITION.

12. GROUPS OF SHRUBS SHALL BE PLACED IN A CONTINUOUS MULCH BED WITH SMOOTH CONTINUOUS LINES. ALL MULCHED BED EDGES SHALL BE CURVILINEAR IN SHAPE FOLLOWING THE CONTOUR OF THE PLANT MASS UNLESS OTHERWISE NOTED. TREES LOCATED WITHIN FOUR FEET OF SHRUB BEDS SHALL SHARE SAME MULCH BED. 13. NO EXISTING TREES SHALL BE REMOVED WITHOUT WRITTEN AUTHORIZATION FROM THE OWNER EXCEPT WHERE NOTED ON PLANS. NO GRUBBING SHALL OCCUR WITHIN EXISTING TREE

SHALL CONTACT LANDSCAPE ARCHITECT FOR RESOLUTION. FAILURE TO MAKE SUCH CONFLICTS KNOWN TO THE OWNER OR LANDSCAPE ARCHITECT WILL RESULT IN CONTRACTOR'S LIABILITY LARGE GROWING PLANTS ARE NOT TO BE PLANTED IN FRONT OF WINDOWS, UNDER BUILDING OVERHANGS, OR IN DRAINAGE SWALES. SHRUBS PLANTED NEAR HVAC UNITS TO BE

TREES SHALL BE LOCATED A MINIMUM OF 3 FEET FROM WALLS AND WALKS WITHIN THE PROJECT. IF CONFLICTS ARISE BETWEEN ACTUAL SIZE OF AREA AND PLANS, CONTRACTOR

LOCATED SO THAT SHRUBS AT MATURITY WILL MAINTAIN I-FOOT AIRSPACE BETWEEN UNIT AND PLAN. CONTRACTOR TO SLIGHTLY ADJUST PLANT LOCATIONS IN THE FIELD AS NECESSARY TO BE CLEAR OF DRAINAGE SWALES AND UTILITIES. FINISHED PLANTING BEDS SHALL BE GRADED SO AS TO NOT IMPEDE DRAINAGE AWAY FROM BUILDINGS.

17. TREE STAKING SHALL BE DONE PER DETAILS. CONTRACTOR SHALL ENSURE THAT TREES REMAIN VERTICAL AND UPRIGHT FOR THE DURATION OF THE GUARANTEE PERIOD.

18. ALL TREE PITS, SHRUB BEDS AND PREPARED PLANTING BEDS ARE TO BE COMPLETELY EXCAVATED IN ACCORDANCE WITH THE PLANTING DETAILS.

19. MULCH IS TO BE DOUBLE SHREDDED HARDWOOD BARK FOR TREES AND SHRUBS.

MD-DC-VA PART 1-EXTERIOR LANDSCAPE INSTALLATION, SECTION 1.12 (A-G) AT WWW.LCAMDDCVA.ORG.

20. CROWN OF ROOT FLARE SHALL BE EVEN WITH GRADE OR MAXIMUM 3" HIGHER (AFTER SETTLING) THAN ADJACENT SOIL.

21. TAGS AND TWINE ARE TO BE REMOVED AND BURLAP IS TO BE ROLLED BACK ONE-HALF ON ALL B#B PLANT MATERIAL. BASKET IS TO BE CUT HALFWAY DOWN THE ROOTBALL.

22. SHRUBS SHALL BE TRIANGULARLY SPACED AT SPACING SHOWN ON PLANTING PLANS WHERE MASSING IS INDICATED.

23. SHADE TREES: HEIGHT SHALL BE MEASURED FROM THE CROWN OF THE ROOT FLARE TO THE TOP OF MATURE GROWTH. SPREAD SHALL BE MEASURED TO THE END OF BRANCHING EQUALLY AROUND THE CROWN FROM THE CENTER OF THE TRUNK. MEASUREMENTS ARE NOT TO INCLUDE ANY TERMINAL GROWTH. SINGLE TRUNK TREES SHALL BE FREE OF "V" CROTCHES THAT COULD BE POINTS OF WEAK LIMB STRUCTURE OR DISEASE INFESTATION.

SHRUBS: HEIGHT SHALL BE MEASURED FROM THE GROUND TO THE AVERAGE HEIGHT OF THE TOP OF THE PLANT. SPREAD SHALL BE MEASURED TO THE END OF BRANCHING

EQUALLY AROUND THE SHRUB MASS. MEASUREMENTS ARE NOT TO INCLUDE ANY TERMINAL GROWTH. 24. SUBSTITUTIONS OF PLANT MATERIAL ARE NOT ALLOWED. SUBSTITUTIONS MAY RESULT IN LIABILITY TO THE CONTRACTOR.

25. ALL CONTRACTORS SHALL BE REQUIRED TO COMPLETELY REMOVE ALL TRASH, DEBRIS AND EXCESS MATERIALS FROM THE WORK AREA AND THE PROPERTY (ESPECIALLY AT ALL CURB, GUTTERS AND SIDEWALKS) DAILY DURING INSTALLATION.

26. DEAD PLANTS ARE TO BE REMOVED FROM THE JOB BY THE CONTRACTOR ON A MONTHLY BASIS. CONTRACTOR SHALL MAINTAIN AN UPDATED, COMPREHENSIVE LIST OF ALL DEAD

MATERIALS REMOVED AND PRESENT A COPY OF THE LIST TO THE OWNER AT THE END OF EVERY MONTH DURING THE CONTRACT PERIOD. 27. CONTRACTOR SHALL BE RESPONSIBLE TO REGRADE, HYDRO-SEED, STRAW MULCH, AND TACK ALL LAWN AREAS DISTURBED AS THE RESULT OF HIS WORK.

ONLY UPON COMPLETION OF A SATISFACTORY PLANTING INSPECTION BY THE CITY FORESTER. CONTRACTOR SHALL GUARANTEE TO OWNER ALL LANDSCAPE IMPROVEMENTS, INCLUDING SEEDING, FOR ONE FULL YEAR AS REQUIRED BY THE SPECIFICATIONS. CONTRACTOR MUST CONTACT THE OWNER AND CITY FORESTER AT LEAST 10 WORKING DAYS IN ADVANCE TO SCHEDULE ACCEPTANCE INSPECTION(S). CONTRACTOR MUST REPLACE ALL DEAD OR UNACCEPTABLE PLANTS DURING THE FOLLOWING RECOMMENDED PLANTING SEASON. 29. THE SPECIFICATIONS FOR ALL WORK INCLUDED IN THIS CONTRACT SHALL BE FROM THE LANDSCAPE SPECIFICATION GUIDELINES BY THE LANDSCAPE CONTRACTORS ASSOCIATION MD-DC-VA (LCA), CURRENT EDITION,

28. THE OWNER IS REQUIRED TO WARRANTY THE TREES COUNTED FOR AFFORESTATION/REFORESTION FOR FIVE YEARS TO THE CITY OF ROCKVILLE. THE WARRANTY PERIOD SHALL BEGIN

UNLESS OTHERWISE NOTED ON THESE PLANS. 30. ANY PLANTING WHICH IS SHOWN ADJACENT TO CONDENSOR UNITS SHALL BE PLANTED AS REQUIRED TO SCREEN THE UNITS. SHOULD THE CONDENSOR UNITS BE INSTALLED IN LOCATIONS DIFFERENT FROM THOSE SHOWN ON THE PLAN IT WILL BE THE CONTRACTOR'S RESPONSIBILITY TO INSTALL THE MATERIALS AROUND THE CONDENSORS AND TO ADJUST OTHER

31. FOR INFORMATION REGARDING APPROPRIATE PLANTING PERIODS FOR DIFFERENT SPECIES, SEE THE LATEST EDITION OF THE LANDSCAPE SPECIFICATION GUIDELINES FROM THE LANDSCAPE CONTRACTORS ASSOCIATION OF

LANDSCAPE PLAN

	L2.01
PROJECT NO.	2004.115.33
SHEET NO.	1 OF 1

Minimum Size of Planting Islands within Internal Landscape Area

Required: Islands parallel to parking spaces = 9' wide, min., and 10' long, min. 9.0' wide, min.; 17.0' long, min. Islands at the heads of parking spaces = 10' wide, min. 4.d.3(a) Residential Zone Standards Zoning Ordinance, Article 13, MIXED USE ZONES Sec. 25.13.05-b.(1) Development Standards- Open Area Open area for sites in Rockville Pike Neighborhood Plan is 15% of project area or 2,900 s.f. 2,984 s.f. = 15.4% of project area Sec. 25.13.05-b.(1) Development Standards- Public Use Space
Required: Public use space for sites in Rockville Pike Neighborhood Plan is 15% of project area or 2,900 s.f. Provided: 6,617 s.f. = 34% of project area Zoning Ordinance, Article 17, LANDSCAPING AND SCREENING REQUIREMENTS Scc. 25.17.02-d. Screening of Mechanical Equipment in all zones other than Single Dwelling Unit Residential
Required: Screening from public view at ground level from the property edge Three evergreen trees to block from adjoining property and street right-of-way Scc. 25.17.02-e. Screening of Trash, Recycling and Waste Oil/Grease Collection Areas enclosures in all zones other than Single Dwelling Unit Residential.
 Sec. 25.17.03-b.3
 Screening of Utility Equipment in non-residential and non-mixed-use zones

 Required:
 a.

 Vegetative or constructed Screening on four sides of the equipment with 80% min. opacity
 If vegetative, provide 80% opacity within one year If constructed, materials must be complementary to building architecture d. Location to minimize visual impact; cluster utility equipment with mechanical and waste disposal equipment Provided: Subject property is zoned MXCD: Utility equipment required to be underground or in an enclosed building

Min. Width Shade Shade Provided Trees Trees Trees *Pursuant to section 4.d.2(b)(iv) a reduction of the landscape strip is being requested as part of this application. Existing fence in place in conjunction with proposed landscaping per requirement. Internal Landscaping of Surface Parking Facility

Required: Minimum 5% of internal parking facility area to be landscaped with shade trees Total internal parking facility area = 6,802 s.f. 5% of internal area = 340 s.f. Total internal landscaped area = 482 s.f. (7%) Number of trees to be planted in landscaped area:

LANDSCAPE REQUIREMENTS Section 4, 'Landscaping, Screening and Lighting Manual', effective May 18, 2015 and Article 17, Rockville Zoning Ordinance (Sec. 25.17)

Minimum 1 Tree per 40 ft. of frontage (1 Ornamental Tree = .5 Shade Tree)

Minimum 1 shade tree per 40 ft. of lot perimeter (1 Ornamental Tree = .5 Shade Tree)
Minimum 15 shrubs per 40 ft. of lot perimeter (1 Evergreen Tree = 5 Shrubs)

Minimum 15 shrubs per 40 ft. of frontage (1 Evergreen Tree = 5 Shrubs)

FOR UTILITY LOCATIONS **CONTACT "ONE CALL" AT 811 AT LEAST 48 HOURS** Know what's **below**. PRIOR TO CONSTRUCTION Call before you dig.

General Planting Notes — Quality Assurance

9 Clethra alnifolia 'Sixteen Candles'

PLO 28 Prunua laurocerasus 'Otto Luyken'

WFA 9 Weigela florida 'Alexandra'

*IGL 6 llex glabra

1. All plant material shall be in accordance with the American Standard for Nursery Stock Latest Edition, published by AmericanHort.

2. All plants shall be wholesome, healthy, vigorous, free from plant diseases, insect pests and their eggs, and shall have healthy, normal top and root systems. Plants shall be nursery—grown stock and freshly dug.

Sixteen Candles Summerswee

Wine & Roses Weigela

#3 Cont.


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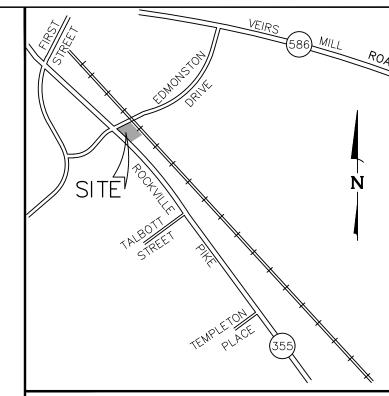
#3 Cont.

#3 Cont. 36" o.c.

36" o.c.

42" o.c.




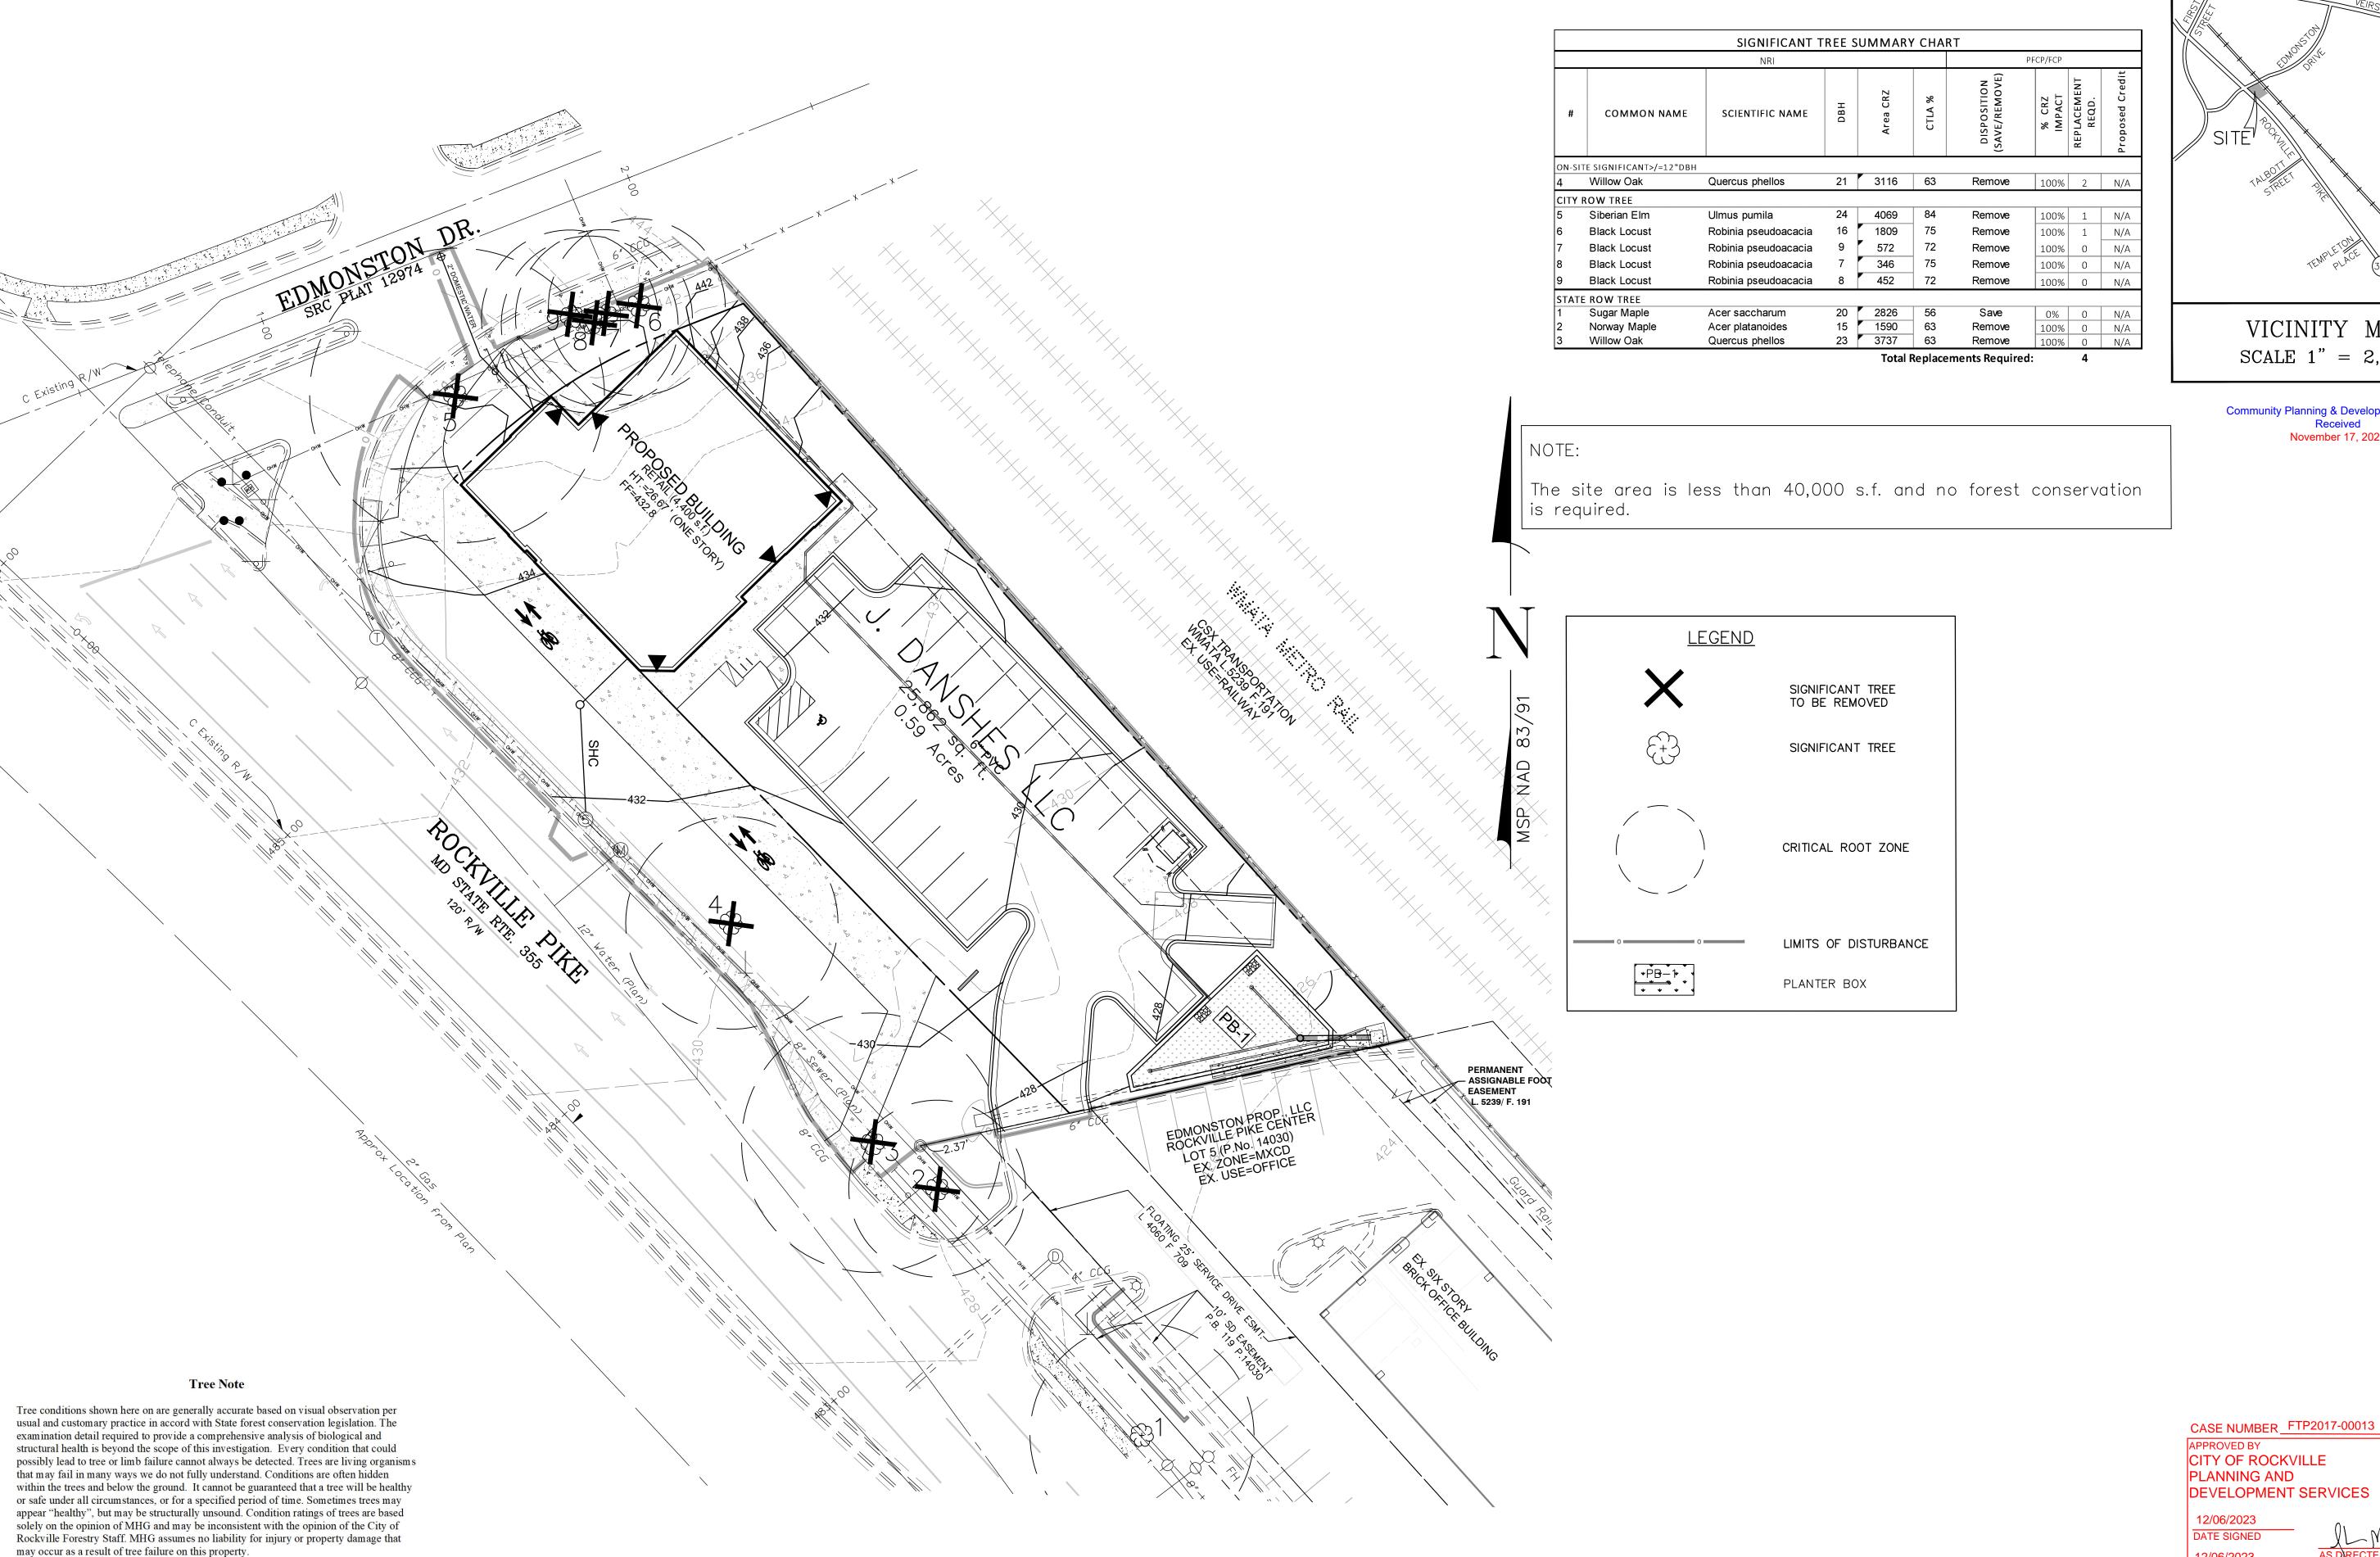

VICINITY MAP SCALE 1" = 2,000"

Community Planning & Development Services

November 17, 2023

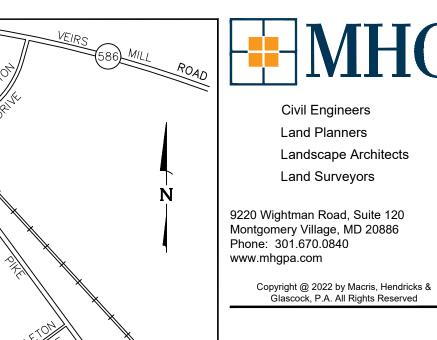

RANK C. JOHNSON 11/17/2023

MD DEPT. OF NATURAL RESOURCES
COMAR 08.19.06.01

Civil Engineers Land Planners

Land Surveyors

Landscape Architects

Qualified Professional Certification I hereby certify that the information shown hereon is correct and that this plan has been prepared in

and county forest conservation legislation.

accordance with the requirements of the existing state

OWNER: J DANSHES, LLC 9213 WINTERSET DR POTOMAC, MD 20854

jdanshes@yahoo.com

ARCHITECT: GTM ARCHITECTS 7735 OLD GEORGETOWN ROAD SUITE 700 BETHESDA, MD, 20814 JEFF WHITMAN, RA 240-333-2067

MILLER, MILLER & CANBY 200-B MONROE STREET ROCKVILLE, MD, JODY KLINE 301-738-2051

REVISIONS

DESCRIPTION

TAX MAP GR561

WSSC 217NW06

BJD

FCJ

1"= 20'

12/2022

1 of 2

L. 44329 F. 159

THE PIKE

SHEET NO.

4TH ELECTION DISTRICT

CITY OF ROCKVILLE MARYLAND DANSHES CENTER ON

ST. MARY'S PARCEL P214

PROJ. MGR DRAWN BY SCALE

DEVELOPMENT SERVICES

GRAPHIC SCALE

12/06/2023

DATE APPROVED

	L9.01
PROJECT NO.	2004.115.33

PRELIMINARY FOREST CONSERVATION PLAN

Community Planning & Development Services Received September 22, 2023

> Civil Engineers Land Planners Landscape Architects Land Surveyors

9220 Wightman Road, Suite 120 Montgomery Village, MD 20886 Phone: 301.670.0840 www.mhgpa.com

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09/21/2023

RECOGNIZED AS QUALIFIED PROFESSIONAL BY MD DEPT. OF NATURAL RESOURCES COMAR 08.19.06.01

Qualified Professional Certification I hereby certify that the information shown hereon is correct and that this plan has been prepared in accordance with the requirements of the existing state and county forest conservation legislation.

OWNER: J DANSHES, LLC 9213 WINTERSET DR POTOMAC, MD 20854

jdanshes@yahoo.com

240-333-2067

ARCHITECT: GTM ARCHITECTS 7735 OLD GEORGETOWN ROAD SUITE 700 BETHESDA, MD, 20814 JEFF WHITMAN, RA

ATTORNEY: MILLER, MILLER & CANBY 200-B MONROE STREET ROCKVILLE, MD, JODY KLINE 301-738-2051

TAX MAP GR561 WSSC 217NW06

L. 44329 F. 159

4TH ELECTION DISTRICT CITY OF ROCKVILLE MARYLAND

DANSHES CENTER ON THE PIKE

ST. MARY'S PARCEL P214

CASE NUMBER FTP2017-00013

DEVELOPMENT SERVICES

CITY OF ROCKVILLE

PLANNING AND


DATE APPROVED

PROJ. MGR BJD DRAWN BY 1"= 20' 12/2022

PRELIMINARY FOREST CONSERVATION PLAN


> L9.02 2004.115.33


PROJECT NO. 2 OF 2 SHEET NO.

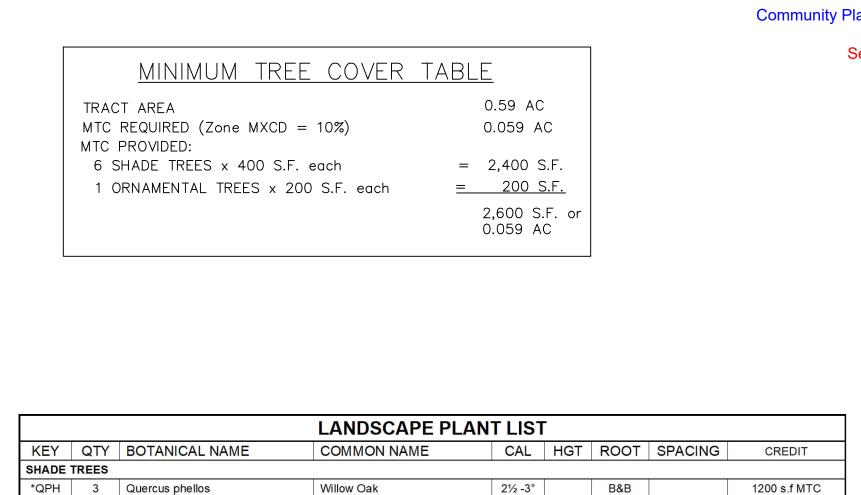

LANDSCAPE PLANT LIST								
KEY	QTY	BOTANICAL NAME	COMMON NAME	CAL	HGT	ROOT	SPACING	CREDIT
SHADE	TREES		·					
*QPH	3	Quercus phellos	Willow Oak	2½ -3"		B&B		1200 s.f MTC
KPA	5	Koelreuteria paniculata	Golden Raintree	2½ -3"		B&B		
PSK	3	Prunus serrulate 'Kwanzan'	Kwanzan Cherry	2½ -3"		B&B		2 Replacement
ZSV	3	Zelkova serrata 'Village Green'	Village Green Japanese Zelkova	2½ -3"		B&B		2 Replacement 1200 s.f MTC
EVERGE	REEN TR	EES						
*JVT	1	Juniperus virginiana 'Taylor'	Taylor Eastern Redcedar		5-6'	B&B		200 s.f MTC
IAF	5	Ilex x attenuate 'Fosteri'	Foster Holly		5-6'	B&B		
ORNAM	ENTAL T	REES		·				
*OAR	6	Oxydendron arboretum	Sourwood	2½ -3"		B&B		
* Native)	1			1	ı	TOTAL:	4 Replacement

2600 s.f. MTC

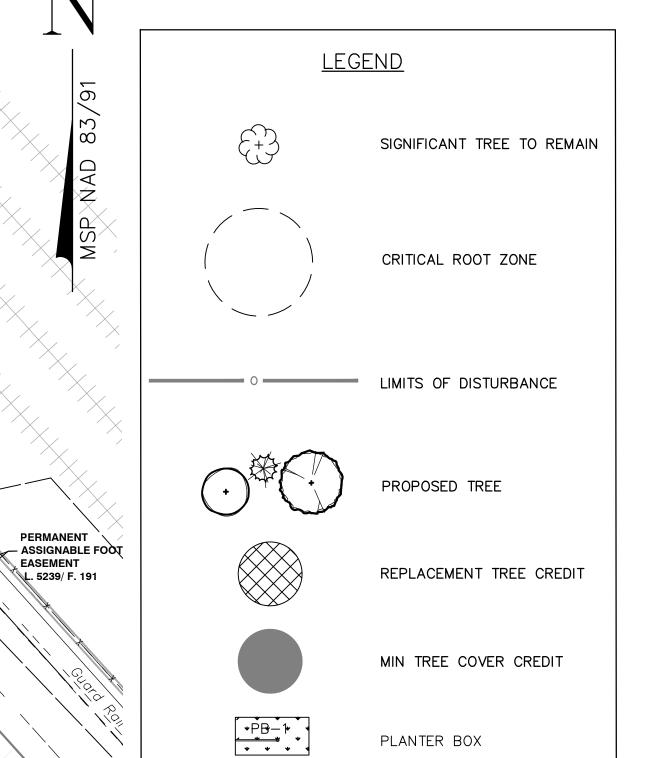

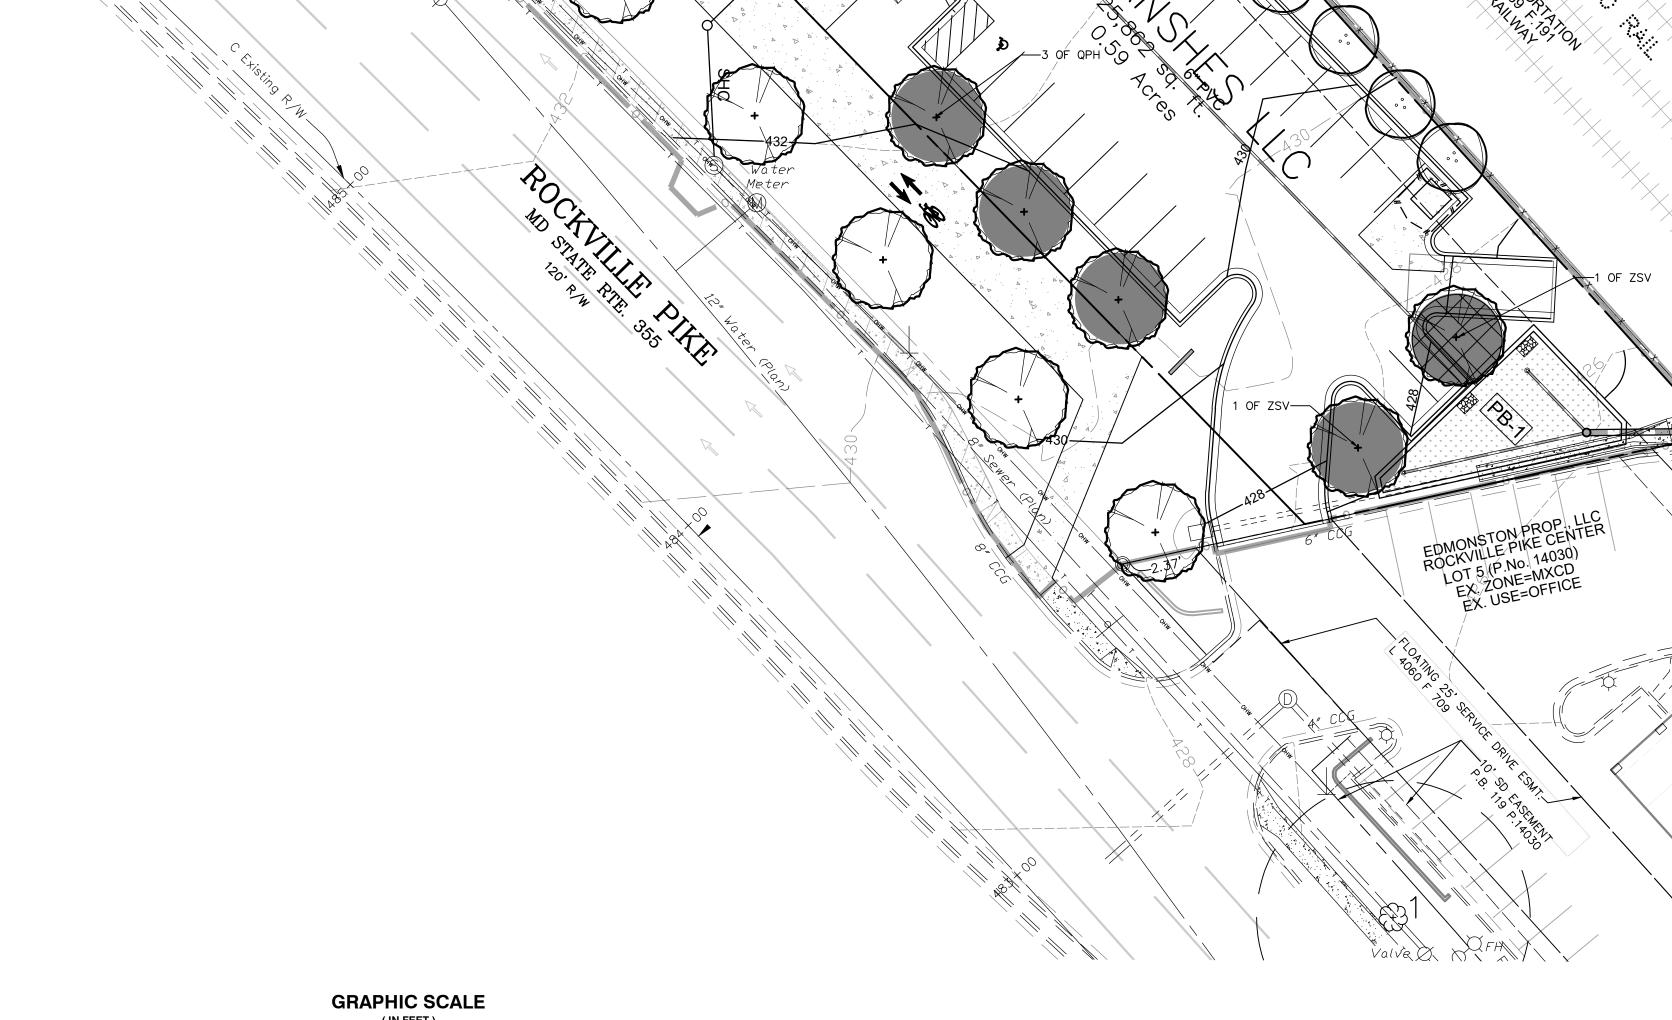

L.6434 F.324

FOR UTILITY LOCATIONS CONTACT "ONE CALL" AT 811 **AT LEAST 48 HOURS** Know what's below. PRIOR TO CONSTRUCTION

Call before you dig.



III Maryland Avenue | Rockville, Maryland 20850-2364 | 240-314-5000 www.rockvillemd.gov

August 28, 2023

Mr. Joel Danshes J Danshes, L.L.C. 9213 Winterset Drive Potomac, Maryland 200854

SUBJECT:

900 Rockville Pike - Danshes' Center on the Pike - Pre-Application SWM Concept

Approval PJT2023-00016, SMC2023-00009

Dear Mr. Danshes:

The Pre-Application Stormwater Management (SWM) Concept (Concept) received for the above referenced site is conditionally approved. Staff has determined that the Pre-Application SWM Concept, as described below, achieves on-site Environmental Site Design (ESD) to the Maximum Extent Practicable (MEP). This Pre-Application SWM Concept approval establishes ESD to the MEP as a PE of 1.80-inch for this project which is 100 percent of the required ESD volume (ESD_v).

This site is 0.59 acre and is identified as Parcel 214, St. Mary's, zoned Planned Development – Champion Billiards (PD-CB) with a designated equivalent zone of Mixed-Use Corridor District (MXCD), situated at 900 Rockville Pike on the southeast corner of the intersection of Edmonston Drive and MD-355. The proposed development includes the construction of a 4,400 square foot retail building, a surface parking lot and sidewalks, and frontage improvements for a 15-foot shared-use path. The property is in Lower Rock Creek Watershed. The on-site soil is designated as Urban Land which is classified as hydrologic soil group (HSG) D.

According to the Rockville City Code (Code), Chapter 19, Section 19-2 Definitions of the Rockville City Code, the Site qualifies as Development because it proposes construction on a property where existing imperviousness is less than 40 percent of the site. The site is currently a vacant lot which is 3.18 percent impervious.

In accordance with the Code, Chapter 19, Section 19-45, SWM is required for all new and replacement impervious area within the entire site area and the contiguous Rights-of-Way (ROW) as required by section 19-46, including all impervious area previously existing on the site that does not have SWM to current standards. According to the submitted Concept, the total limit of disturbance is 0.44 acre which is 100 percent of the site after the proposed dedication of ROW, and the on-site impervious area subject to SWM is 0.30 acre.

Per the Code, Chapter 19, Section 19-46, SWM also must be provided for imperviousness in a portion of the adjacent Edmonston Drive and MD-355 ROW. Per the submitted Concept, the total impervious area in the adjacent ROW subject to SWM is 0.13 acre.

Mr. Danshes August 28, 2023 Page 2

Your proposed Pre-Application SWM Concept, as shown on the attachment, is summarized as follows:

ON SITE SUMMARY

Proposed new or replacement impervious areas are summarized as:

• One building, a surface parking lot, sidewalks, and associated site improvements.

Total on-site impervious area subject to SWM = 0.30 acre.

Environmental Site Design Measures

- The Concept proposes to provide a $P_E = 1.80$ inches equivalent to 100 percent of the required ESDv in the following on-site measures:
 - One micro-bioretention planter box facility.
- Summary of ESD:
 - > Total ESDv provided = 1,888 cubic feet (cf.)
 - > Total ESDv required = 1,888 cf.

Percentage of ESDv provided = 1,888 cf./1,888 cf. = 100 percent.

Structural Measures and/or Alternative Measures - Monetary Contribution

This Pre-Application SWM Concept Approval does not approve the methods for providing SWM beyond establishing the percent ESDv. However, the Pre-Application SWM proposes:

• Alternative Measures – Monetary contribution in-lieu of providing Qp10 for the on-site imperviousness (0.30 acre).

ROW SUMMARY

• Applicant proposes to provide WQv, Cpv, and Qp₁₀ for imperviousness in the adjacent ROW of Edmonston Drive and MD-355 (0.11 acre) via monetary contribution.

CONDITIONS OF APPROVAL

Staff has determined that ESD to the MEP has been met.

The next step in the City of Rockville (City) two-stage SWM Concept approval is submission of a Development SWM Concept for review and approval by the Department of Public Works (DPW) prior to Planning Commission approval of the Site Plan. In accordance with the Code, Chapter 19, Section 19-44, SWM must be provided by one of the following methods, which are listed in order of priority respectively: on-site ESD measures, on-site structural measures, and alternative measures which may include a monetary contribution.

Mr. Joel Danshes August 28, 2023 Page 3

This Pre-Application SWM Concept is conditionally approved subject to the following conditions, which must be addressed at the stages in the process as indicated below:

The submitted material must:

- 1. Include all plans, on 24" x 36" sheets, computations, and supporting documents as outlined in the City SWM Concept Checklist.
- 2. Demonstrate, with sufficient details and computations, how ESD to the MEP, established by this approval, will be achieved on-site.
- 3. Demonstrate, with sufficient details and computations, compliance with the full SWM requirements will be in accordance with the Code, Sections 19-43 and 19-44.
- 4. Include horizontal and vertical information to support the design, including underdrain pipes and overflow structures, and conveyance to the proposed microbioretention SWM facility.
- 5. Provide information that demonstrates that individually sized sub-drainage areas are safely conveyed to the individual ESD measures.
- 6. Submit a revised SWM/Forestry Overlay Plan demonstrating compliance with the Concept approval and the Preliminary Forest Conservation Plan approval.
- 7. Show and label preliminary SWM easements for all proposed SWM facilities. Easements should be sized to allow future inspection and maintenance.
- 8. The City may require an underground structural measure in-lieu of providing full ESD. SWM Alternatives, including monetary contribution as a method to meet SWM requirements, will be reviewed at the Development SWM Concept stage. Fee-in-lieu calculations associated with on-site areas should be presented separately from adjacent ROW areas.
- 9. Prepare a safe conveyance analysis of the downstream storm drain system and receiving stream. This letter establishes the study point as the storm drain pipe located on the east side of the WMATA Metro Rail property as shown on the attached exhibit entitled "900 Rockville Pike Safe Conveyance Analysis Limits." The safe conveyance analysis must be reviewed and approved by DPW prior to approval of the Development SWM Concept. However, this analysis may be reviewed concurrently with the Development SWM Concept.
- 10. Conceptual design for drainage connections to existing storm drains in Washington Metropolitan Area Transit Authority (WMATA) easements and ROWs must be submitted for review prior to the approval of the Development Stormwater Management Concept.
- 11. The Applicant must comply with all requirements of WMATA's Joint Development and Adjacent Construction Manual, Design Criteria, and the provisions of any existing easement on the property. The Applicant must identify all proposed SWM facilities or private storm drain within the WMATA Zone of Influence on the property and provide the City with all correspondence related to compliance with WMATA's requirements. Any significant changes to the proposed development to comply with WMATA's Design Criteria may require the applicant to revise the plan to comply with all stormwater management requirements.

This Pre-Application SWM Concept does not supersede or negate other required project approvals. The Concept approval does not approve the layout or density of the site. The Concept approval is contingent upon compliance of all other City and other governmental agency requirements including, but not limited to, Forestry, Traffic and Transportation, and Planning.

Any significant changes to the proposed development may result in the requirement to submit a revised Pre-Application SWM Concept with review fee for approval by DPW. Mr. Joel Danshes August 28, 2023 Page 4

If you have questions, please contact Principal Civil Engineer Sean Murphy via email at smurphy@rockvillemd.gov or via telephone at 240-314-8535.

Sincerely,

John Scabis, P.E. Chief of Engineering


John Sels


JKS/SKM/kmc

Attachments: 900 Rockville Pike – Danshes' Center on the Pike – Pre-Application SWM Concept Plan, dated August 22, 2023.

900 Rockville Pike - Danshes' Center on the Pike - Safe Conveyance Analysis Limits.

cc: Jim Lapping, Engineering Supervisor
Shaun Ryan, Planning Supervisor
Li Alligood, Principal Planner
Brian Donnelly, Macris, Hendrick & Glascock, P.A.
Jody Kline, Miller, Miller & Canby
SWM Concept file
Permit plan, PJT2023-00016, SMC2023-00009
Day file

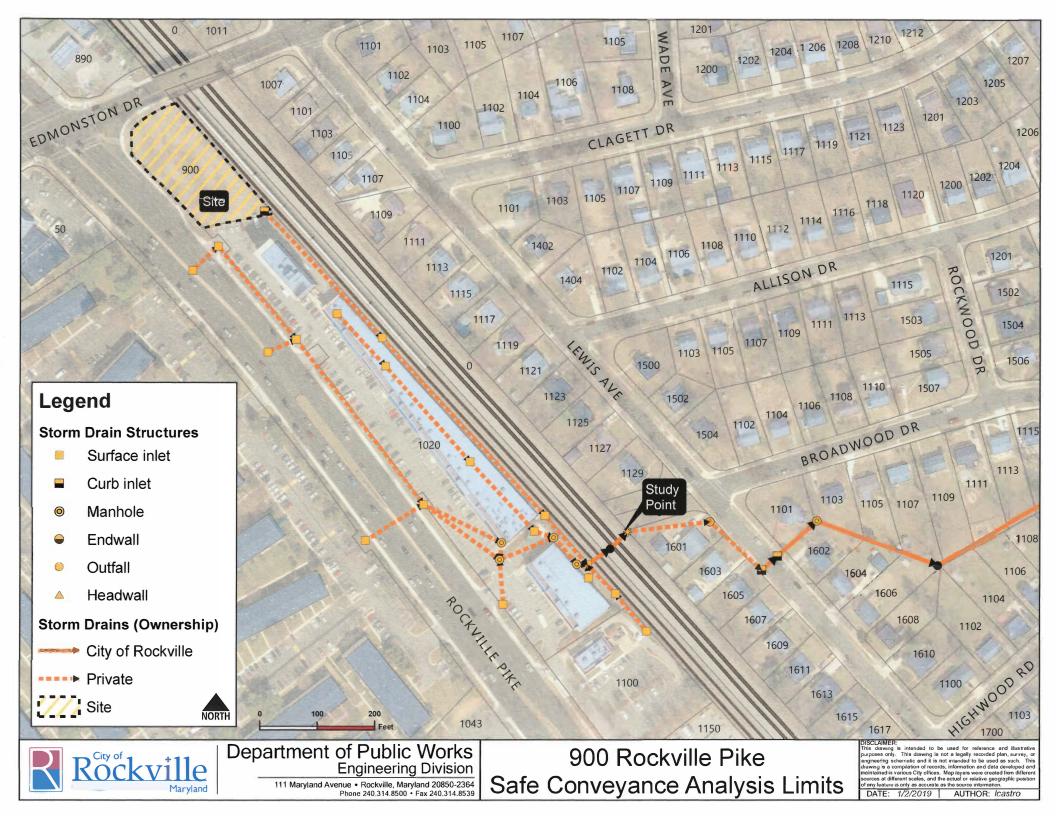

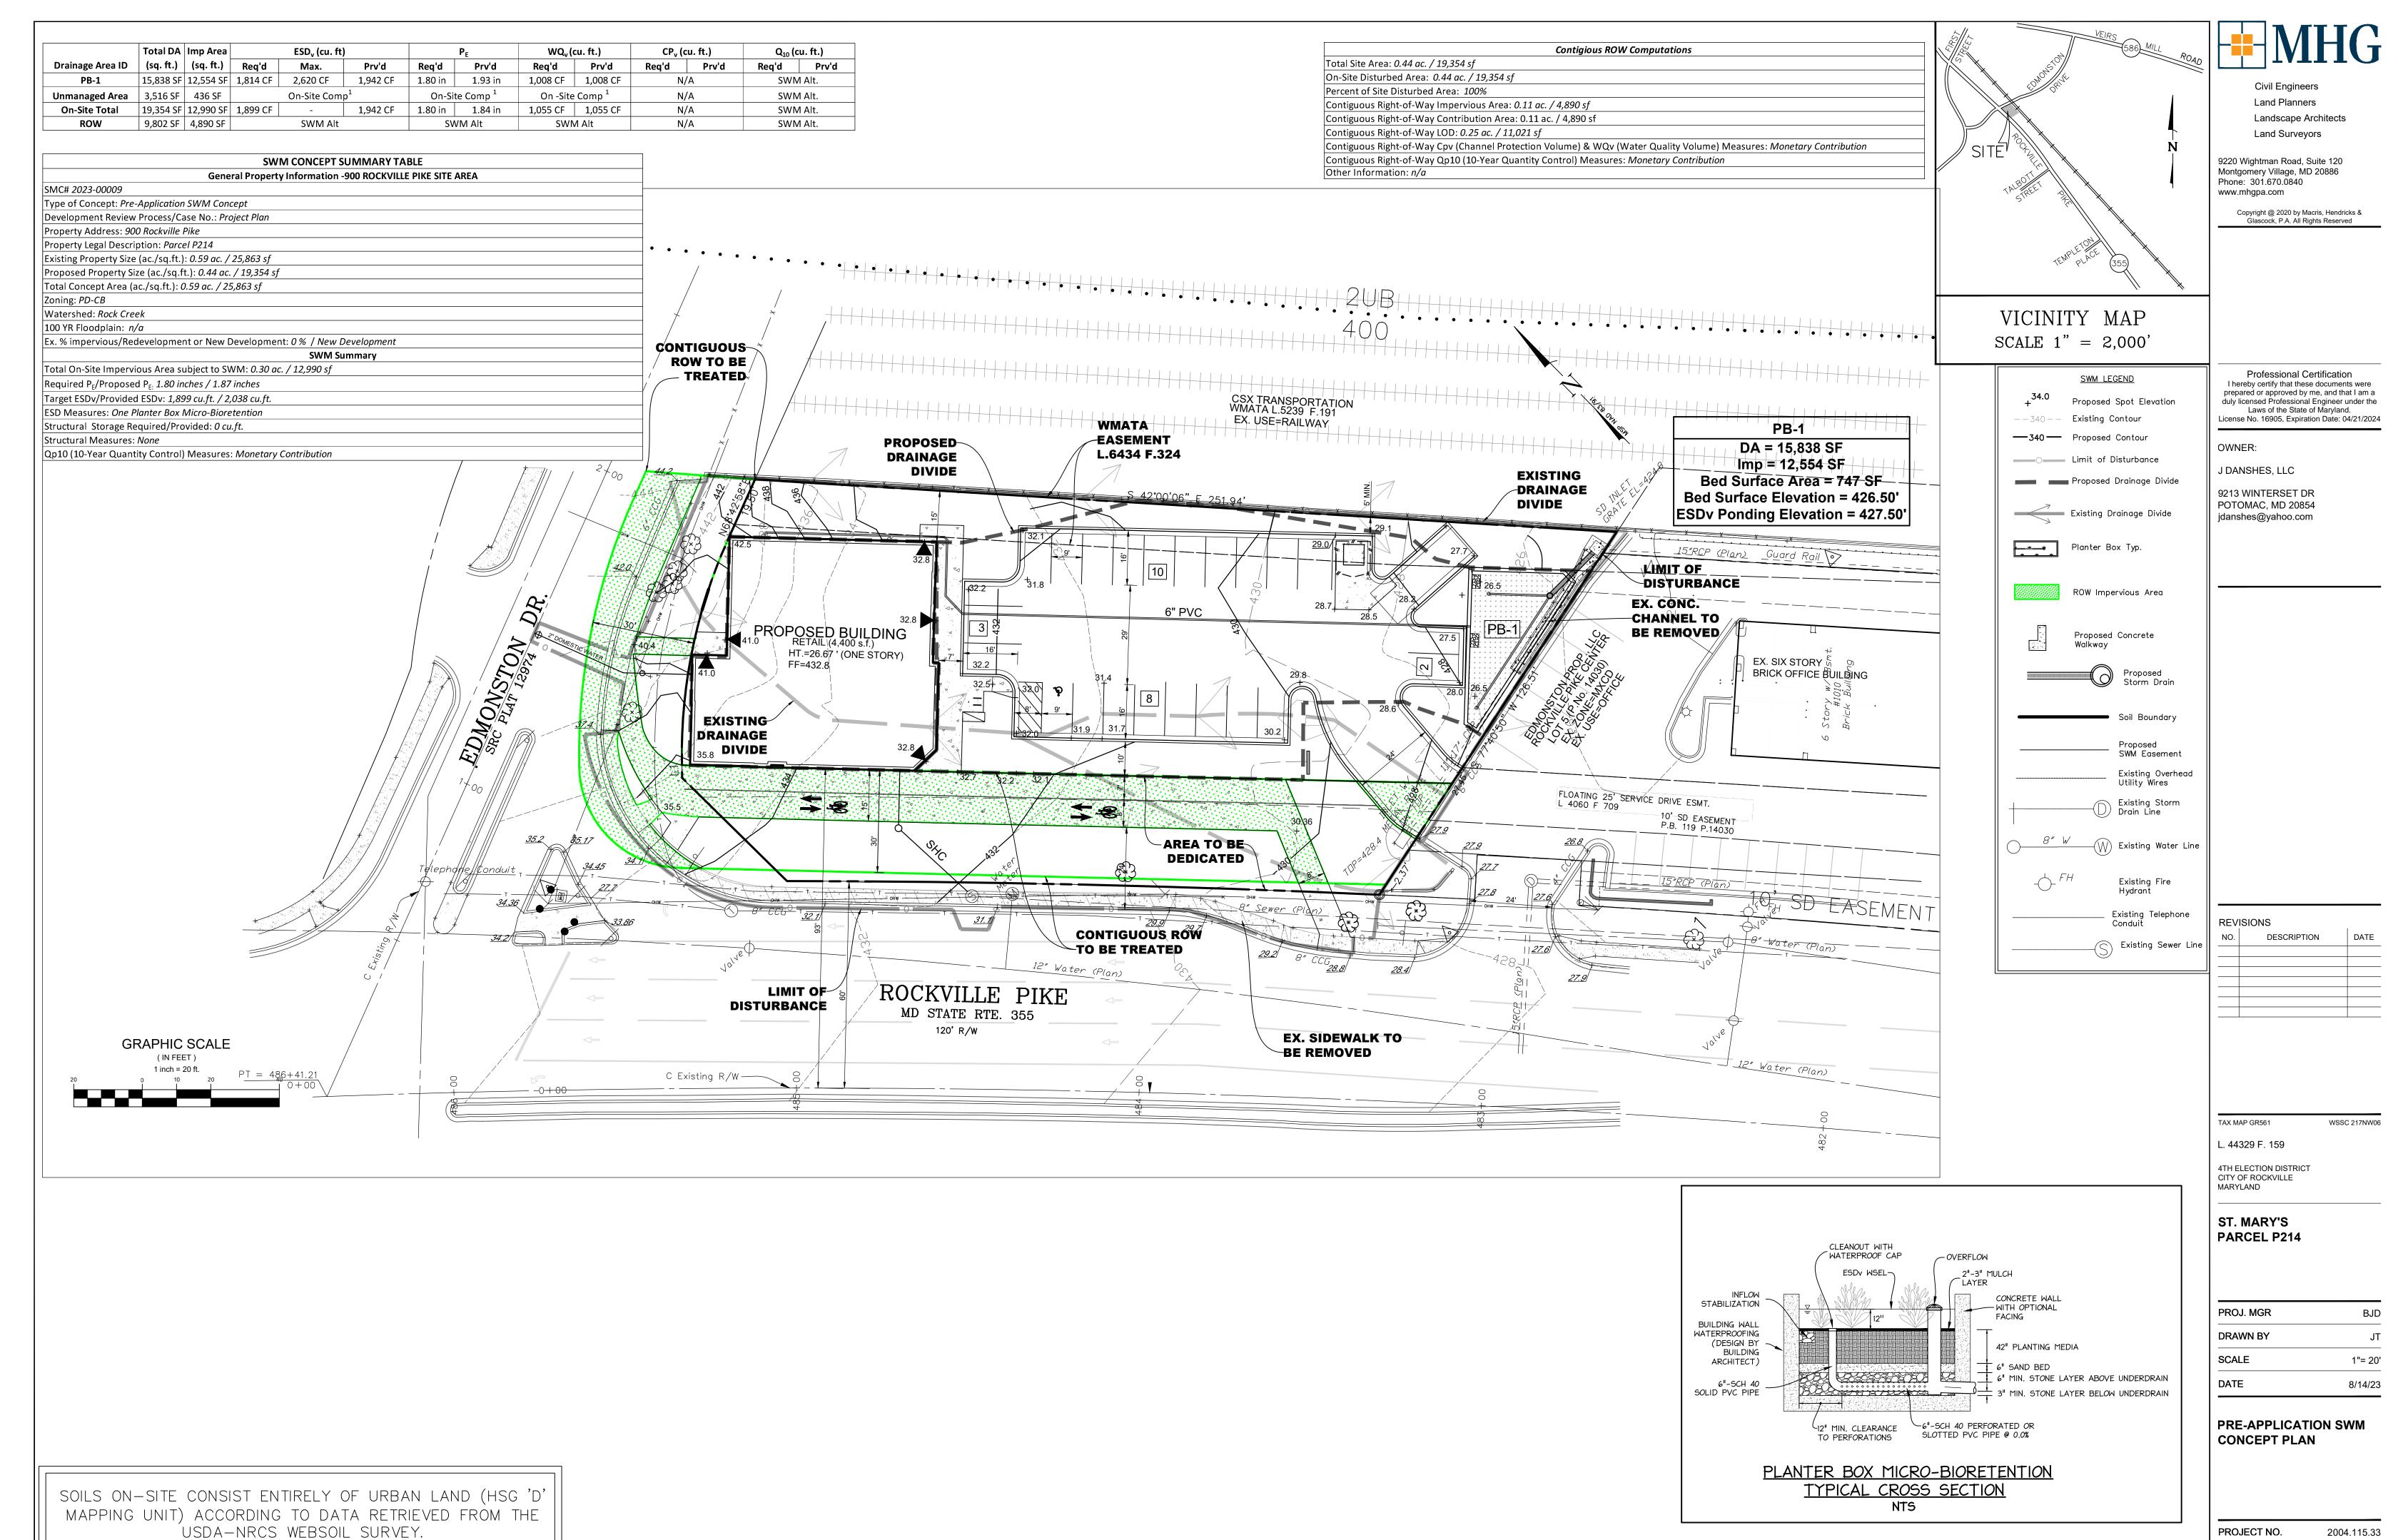

I:\04115\dwg\SC_33_01.dwg, SWM Concept, 8/16/203

THIS PLAN IS FOR STORMWATER MANAGEMENT ONLY

PROJECT NO. 2004.115.33
SHEET NO. 1 OF 1

> DANSHES CENTER ON THE PIKE ST. MARY'S -PARCEL P214 900 Rockville Pike PJT2018-00010

From: James Lapping <jlapping@rockvillemd.gov>

Sent: Monday, December 05, 2022 8:14 AM **To:** Paul pswienton cpswienton@mhgpa.com> **Cc:** Brian Donnelly cbdonnelly@mhgpa.com>

Subject: RE: W&S Authorization

Paul,

I couldn't find an actual Water & Sewer Authorization approval letter for 900 Rockville Pike. The language in the staff report from the 2019 M&C public hearing is below. We'll use the same language when the project moves forward.

Water and Sewer

The applicant is not required to obtain a Water and Sewer Authorization Letter. The proposed amendment represents a reduction in the water and sewer demand from the previously approved Project Plan for the property.

James D. Lapping, P.E.

Engineering Supervisor - Development Review Department of Public Works jlapping@rockvillemd.gov
City of Rockville jlapping@rockvillemd.gov
City of Rockville jlapping@rockvillemd.gov
City of Rockville <a href="mailto:jlappin



From: Paul pswienton pswienton@mhgpa.com>

Sent: Sunday, December 4, 2022 9:46 PM
To: James Lapping < jlapping@rockvillemd.gov >
Cc: Brian Donnelly < bdonnelly@mhgpa.com >

Subject: W&S Authorization

WARNING - External email. Exercise caution.

Hi Jim

Can you please check to see if there is an approved **W&S Authorization** for **900 Rockville Pike** in Rockville. We are doing work on this property and the client believes that there is already a Authorization for this.

Please let me know when you have a chance. Thank you

Paul



Paul A. Swienton
Macris, Hendricks and Glascock, P.A.
Engineers • Planners • Landscape Architects • Surveyors

9220 Wightman Road, Suite 120

Montgomery Village, Maryland 20886-1279

Phone: 301.670.0840 Ext. 1053 Email: pswienton@mhgpa.com





DEPARTMENT OF PUBLIC WORKS 111 Maryland Avenue, Rockville, Maryland 20850, 240-314-8500 WATER AND SEWER

AUTHORIZATION APPLICATION (WSA)

For City Use:	
CPDS Case # _	PJT2025-00022
WSA Case #	

GENERAL PROJECT INFOI Project Name and Address:	RMATION: ST. MARY'S -	- 900 ROCKVILLE PIKE	
Property Description: Subdivision	n: ST. MARY'S Lot(s)	and Block(s)Parcel(s	s) <u>P214</u>
Tax ID(s):04-02406134			
Applicant: J DANSHES LLC		Contact Person:JC	DEL DANSHES
Address:9213 WINTERSET DF			
E-mail Address: jdanshes@yahoo	o.com	Telephone No:	
Property Owner (if different from			
Address:			
E-mail Address:		Telephone No:	
Engineering Firm: MHG			
Address: <u>9220 WIGHTMAN RO</u> A			
E-mail Address: pswienton@mhg	gpa.com	Telephone No: 301	-670-0840
Submittal Requirements: (Check to confirm that items hav Corresponding CDPS Plan Preliminary profiles for shallow	☐ Preliminary profiles for se		
Requested Service: (Check all that apply) Public Water Main Extension Public Sewer Extension Fire Hydrant	[x Water Service Connex Sewer Service Connex Other:		Service Connection
Special Project Conditions: (Check all that apply) ☐ Pressure Sewer ☐ Off Site E ☐Other (specify)	1	n-Site Easement Required	
Current Use Information:	II.'' (CE 1)	ANVE /II (1) / II	
Specific Use	Unit (SF, each, etc.)	AWF/Unit (g.p.d)/per Use *	* Average Demand (g.p.d)**
		Total =	Total =
Proposed Use Information (in Specific Use	clude any Current Uses th Unit (SF, each, etc.)	nat are to remain): AWF/Unit (g.p.d)/per Use**	* Average Demand (g.p.d)**
RETAIL	4,400 SF	0.069	304
	_	Total = 0.069	Total = 304
**AWF = Average Wastewater F	Flow. Flow and demand rate		F must be from the WSSC Pipeline
Design Manual, latest edition. If Source:		ailable for a specific use, state the s	source below.
SIGNATURE OF PROPERT If Applicant is the Property Owner:	Y OWNER/APPLICAN	<u>1:</u>	
Property Owner's Signature:		Date	
Name and Title (Please Print):			
	perty Owner and I have aut	thorized the filing of this applicatioDate	
Updated July 9, 2019			

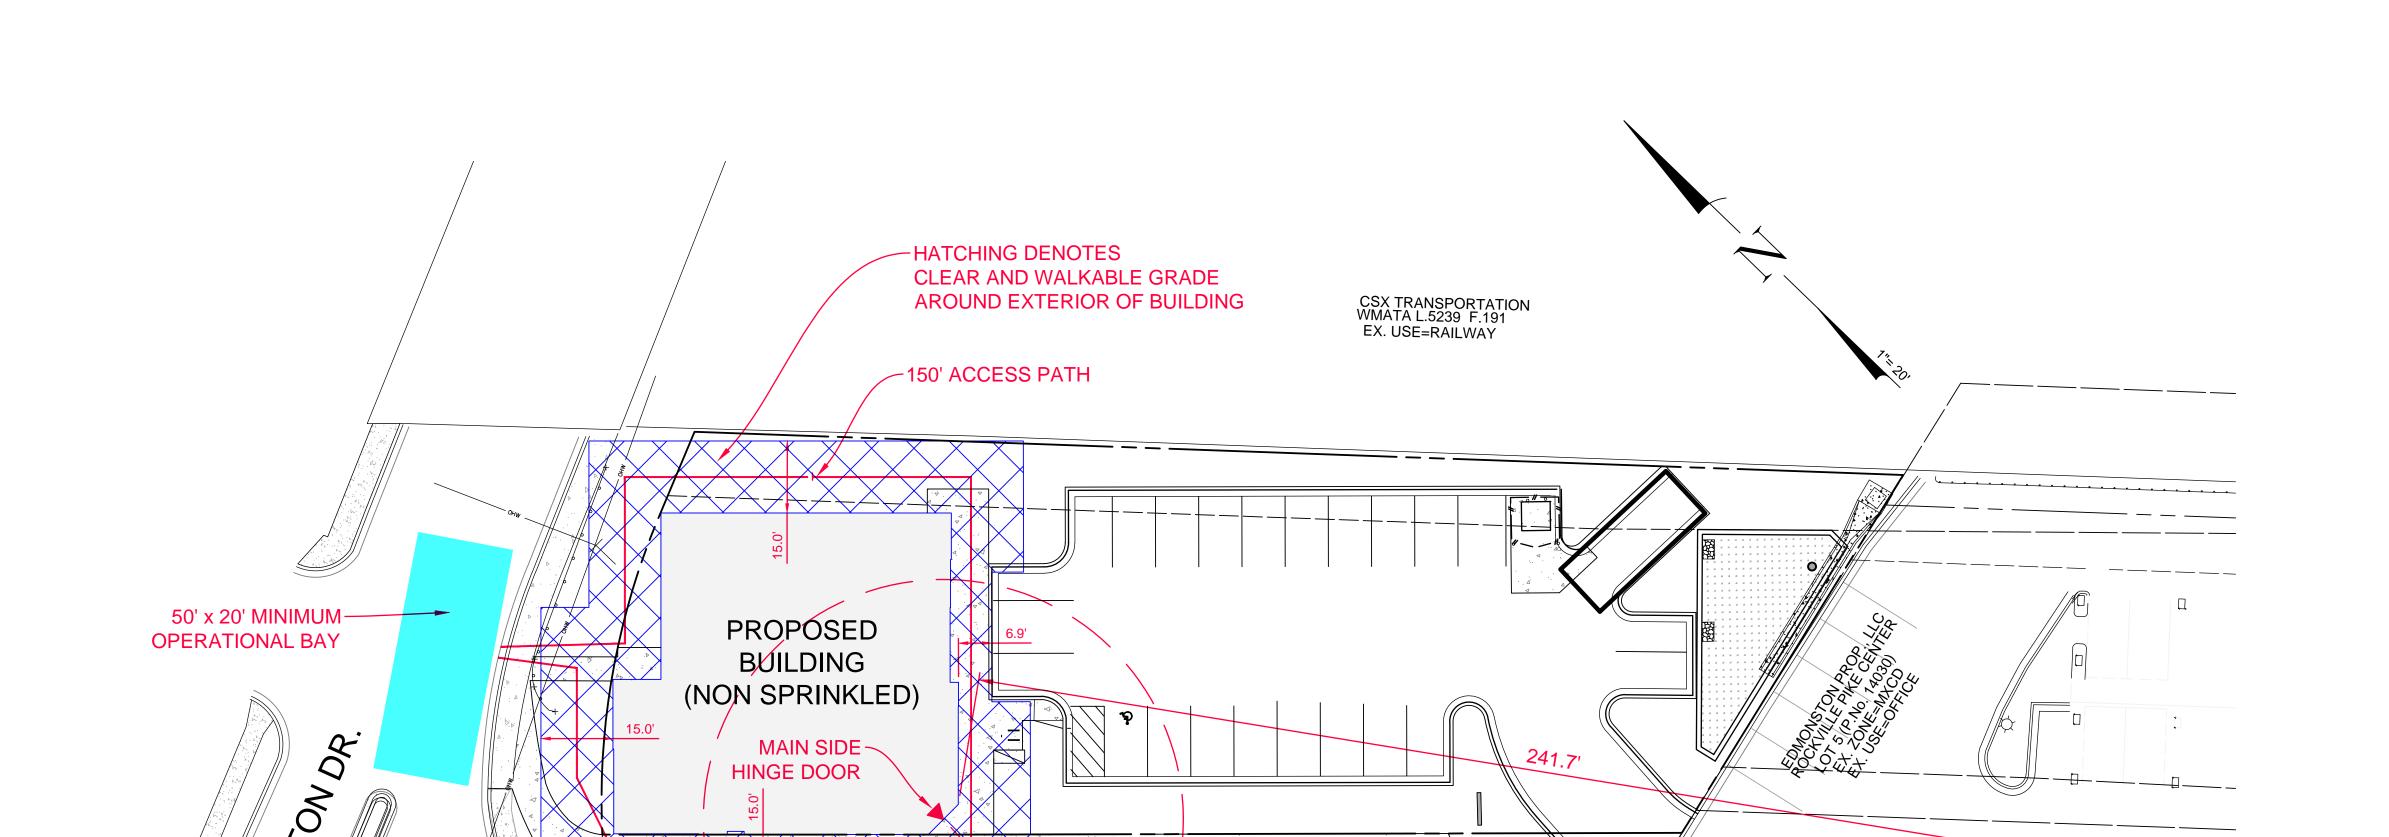

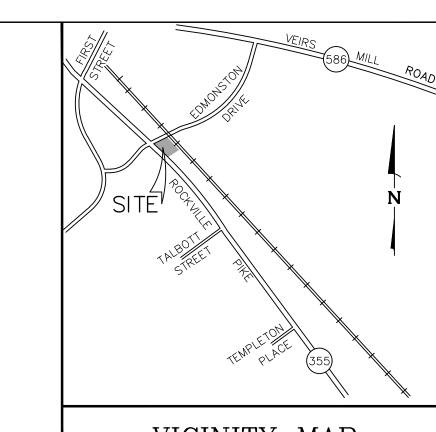

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9220 Wightman Road, Suite 120 Montgomery Village, MD 20886 Phone: 301.670.0840 www.mhgpa.com

Civil Engineers Land Planners

Land Surveyors

Landscape Architects

VICINITY MAP SCALE 1" = 2,000'

LEGEND

APPARATUS

50 X 20' MIN

ACCESS MOVEMENT

OPERATIONAL BAY

15' CLEAR AND WALKABLE GRADE AROUND BUILDING

MAIN EXTERIOR DOORS

EXISTING FIRE HYDRANT

FIRE ACCESS PATH

Professional Certification hereby certify that these documents were prepared or approved by me, and that I am a duly licensed Professional Engineer under the Laws of the State of Maryland. Lic. No. 16905 Exp. Date. 04.21.2024

OWNER: J DANSHES, LLC 9213 WINTERSET DR POTOMAC, MD 20854

jdanshes@yahoo.com

ARCHITECT: GTM ARCHITECTS 7735 OLD GEORGETOWN ROAD SUITE 700 BETHESDA, MD, 20814 JEFF WHITMAN, RA

ATTORNEY: MILLER, MILLER & CANBY 200-B MONROE STREET ROCKVILLE, MD, JODY KLINE

240-333-2067

301-738-2051

REVISIONS NO. DESCRIPTION

SUBMIT PROJECT PLAN 12/13/22 ADDRESS DRC COMMENTS 5/8/23

WSSC 217NW06

L. 44329 F. 159 4TH ELECTION DISTRICT CITY OF ROCKVILLE MARYLAND 47.00 DANSHES CENTER ON THE PIKE ST. MARY'S

: 8.25

: 8.25

: 6.0

: 40.0

21.75

Width

Track

Lock to Lock Time

Steering Angle

Fire Truck MC AT-29

PARCEL P214

TAX MAP GR561

PROJ. MGR	BJD
DRAWN BY	JDP
SCALE	1"= 20'
DATE	05/2023

PROJECT PLAN FIRE APPARATUS


ACCESS PLAN

SHEET NO.

EX 1.0 PROJECT NO. 2004.115.33

1 OF 1

\$ R=30.0 ┌─R=50.0' EX. FH +/-200' -EXISTING OVERHEAD CLEARANCE 16.4' -R=30.0' 50' x 20' MINIMUM ROCKVILLE PIKE _R=30.0' **OPERATIONAL BAY** ^{_}R=50.0' MD STATE RTE. 355 SPEED LIMIT POSTED 35 M.P.H

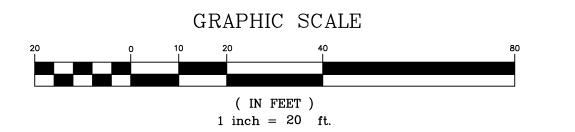

HEIGHT & AREA ANALYSIS NON-SPRINKERED SINGLE STORY = NS	CONSTRUCTION TYPE IIB
GROUND FLOOR BUILDING AREA LIMITATION PER STORY (SM) - MERCANTILE USE GROUP M (IBC 2018 TABLE 506.2)	4,400 SF ACTUAL - 12,500 SF MAX PERMITTED (MERCANTILE - MOST RESTRICTIVE)
ALLOWABLE NUMBER OF STORIES ABOVE GRADE PLANE - MERCANTILE USE GROUP M PER IBC 2018 TABLE 504.4	2 STORIES MAX PERMITTED
ALLOWABLE NUMBER OF STORIES ABOVE GRADE PLANE - BUSINESS USE GROUP B PER IBC 2018 TABLE 504.4	3 STORIES MAX PERMITTED
ACTUAL NUMBER OF STORIES (ABOVE GRADE PLANE)	1 STORY (PROPOSED)
ALLOWABLE H.T ABOVE GRADE PLANE PER IBC 2018 TABLE 504.3-MERCANTILE USE GROUP M OR BUSINESS USE GROUP B	55 FEET
ACTUAL H.T ABOVE GRADE PLANE PER IBC 2018 TABLE 504.3	27′
REQUIRED SEPARATION OF B/M/S-1 OCCUPANCIES PER 2018 IBC TABLE 508.4	ND SEPARATION REQUIRED
REQUIRED SEPARATION OF BUSINESS & MERCANTILE OCCUPANCIES PER 2015 NFPA 101 TABLE 6.1.14.4.1(b)	NONE-MIXED OCCUPANCY COMPLIES WITH MOST RESTRICTIVE
WHEREAS THE 2018 NEPA 101 REQUIREMENTS FOR THE SEPARATI	IN DE MULTIPLE BUSINESS &

CODE ANALYSIS	NEW BUILDING
BUILDING CODE	2018 INTERNATIONAL BUILDING CODE
CONSTRUCTION TYPE	IIB
USE GROUP	B or M - (Business or Mercantile)
NUMBER OF STORIES	1
HEIGHT	27′
FULLY SUPPRESSED	ND
FIRE ALARM	ND
HIGH RISE	ND
COVERED MALL	ND
FLOOR AREA (SF) TOTAL "IBC" BUILDING AREA(O	NE STORY) 4,400SF

WHEREAS THE 2018 NFPA 101 REQUIREMENTS FOR THE SEPARATION OF MULTIPLE BUSINESS & MERCANTILE OCCUPANCIES IS MORE RESTRICTIVE, A 2 HOUR FIRE RESISTANCE-RATED HORIZONTAL ASSEMBLY IS REQUIRED